

PHOTOMONTAGE OF VIEW FROM FRENCHS FOREST RD



PHOTOMONTAGE OF VIEW FROM SKYLINE PL

DRAWING No.	NAME	REV	DATE
DA000	COVER PAGE & DRAWING LIST	Α	25.05.18
DA101	SITE ANALYSIS: SITE PLAN	Α	25.05.18
DA102	SITE ANALYSIS: TREES, VIEWS, ACCESS, CLIMATE	Α	25.05.18
DA103	SITE ANALYSIS: CONTEXT - BUILT FORM PLAN	Α	25.05.18
DA104	SITE ANALYSIS: CONTEXT - BUILT FORM SECTIONS	Α	25.05.18
DA105	SITE ANALYSIS: CONTEXT - ACCESS PLAN	Α	25.05.18
DA106	SITE ANALYSIS: CONTEXT - NEIGHBOUR INTERFACES	Α	25.05.18
DA201	SUBDIVISION PLAN	Α	25.05.18
DA202	NEW WORKS ON LOT 1	Α	25.05.18
DA301	BASEMENT & LOWER GROUND CARPARK	Α	25.05.18
DA302	GROUND FLOOR PLAN	Α	25.05.18
DA303	LEVELS 1 & 2 FLOOR PLANS	Α	25.05.18
DA304	LEVELS 3 & 4 FLOOR PLANS	Α	25.05.18
DA305	LEVELS 5 & 6 FLOOR PLANS	Α	25.05.18
DA306	ROOF PLANS	Α	25.05.18
DA401	SECTIONS	Α	25.05.18
DA501	NORTH ELEVATION	Α	25.05.18
DA502	WEST ELEVATION	Α	25.05.18
DA503	SOUTH ELEVATION	Α	25.05.18
DA504	EAST ELEVATION	Α	25.05.18
DA601	MATERIALS AND FINISHES	Α	25.05.18
DA701	ACCESS RAMPS TO CARPARK: SECTIONS	Α	25.05.18
DA801	DEMOLITION PLAN	Α	25.05.18
DA901	BASIX COMMITMENTS -1	Α	25.05.18
DA902	BASIX COMMITMENTS - 2	Α	25.05.18
DA1001	3D PERSPECTIVE	Α	25.05.18
DA1101	SHADOW DIAGRAMS	Α	25.05.18
DA1201	FLOOR AREA CALCULATIONS	Α	25.05.18
DA1202	LANDSCAPE AREA CALCULATIONS	Α	25.05.18
DA1203	SURVEY PLAN	Α	25.05.18
DA1204	GROUND FLOOR PLANS OF EXISTING BUILDINGS	Α	25.05.18
DA1205	FIRST FLOOR PLANS OF EXISTING BUILDINGS	Α	25.05.18



Δ	ORIGINAL ISSUE	28.03

A ORIGINAL ISSUE 28.03.1:

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PROJECT:


Seniors Living 5 Skyline Place Frenchs Forest NSW 2086

SP 49558

## COVER PAGE & DRAWING




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	9. CAR PARKING COMMERCIAL			
Unit Name	Home Story	Element ID	Quantity	
2.4 COM	LOWER GROUND	01	1	
2.4 COM	LOWER GROUND	02	1	
2.4 COM	LOWER GROUND	03	1	
2.4 COM	LOWER GROUND	04	1	
2.4 COM	LOWER GROUND	05	1	
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2.4 COM	LOWER GROUND	07	1	
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2.4 COM	LOWER GROUND	09	1	
2.4 COM	LOWER GROUND	10	1	
2.4 COM	LOWER GROUND	11	1	
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2.4 COM	LOWER GROUND	14	1	
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2.4 COM	LOWER GROUND	22	1	
2.4 COM	LOWER GROUND	23	1	
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2.4 COM	LOWER GROUND	32	1	
2.4 COM	LOWER GROUND	33	1	
2.4 COM	LOWER GROUND	34	1	
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PROJECT:

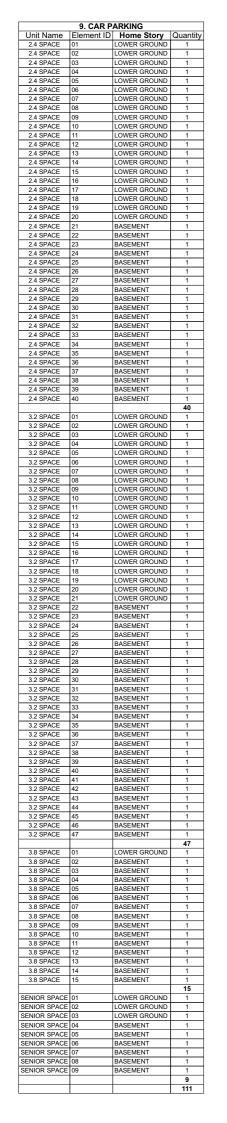
Seniors Living 5 Skyline Place Frenchs Forest NSW 2086

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## BASEMENT & LOWER GROUND CARPARK

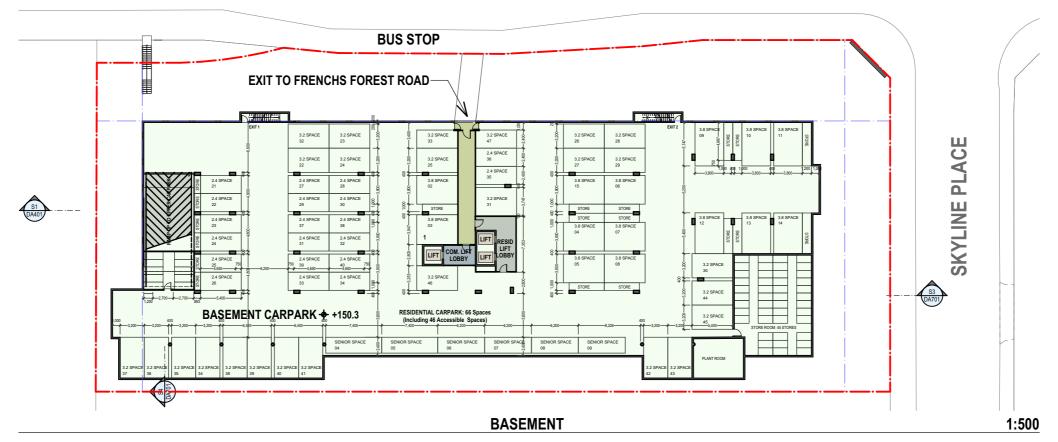



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SUBSET:	PLANS	DA301
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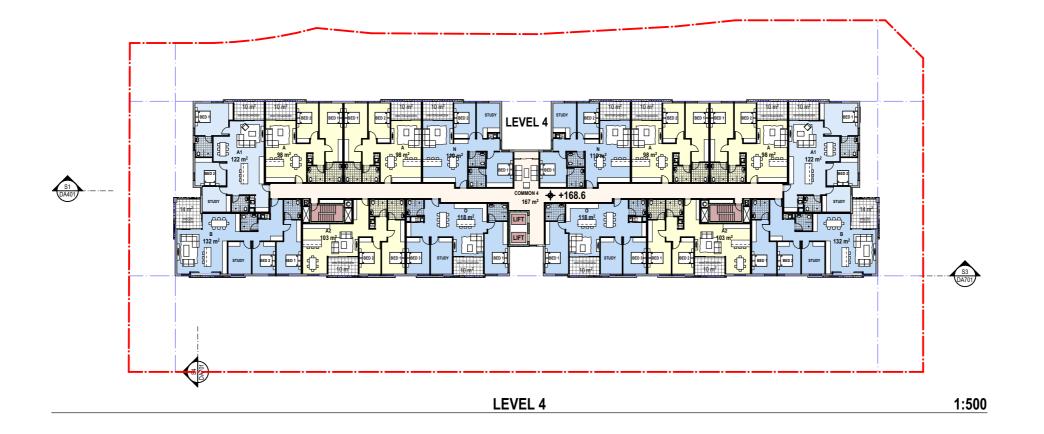
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LEVELS 1 & 2 FLOOR **PLANS** 

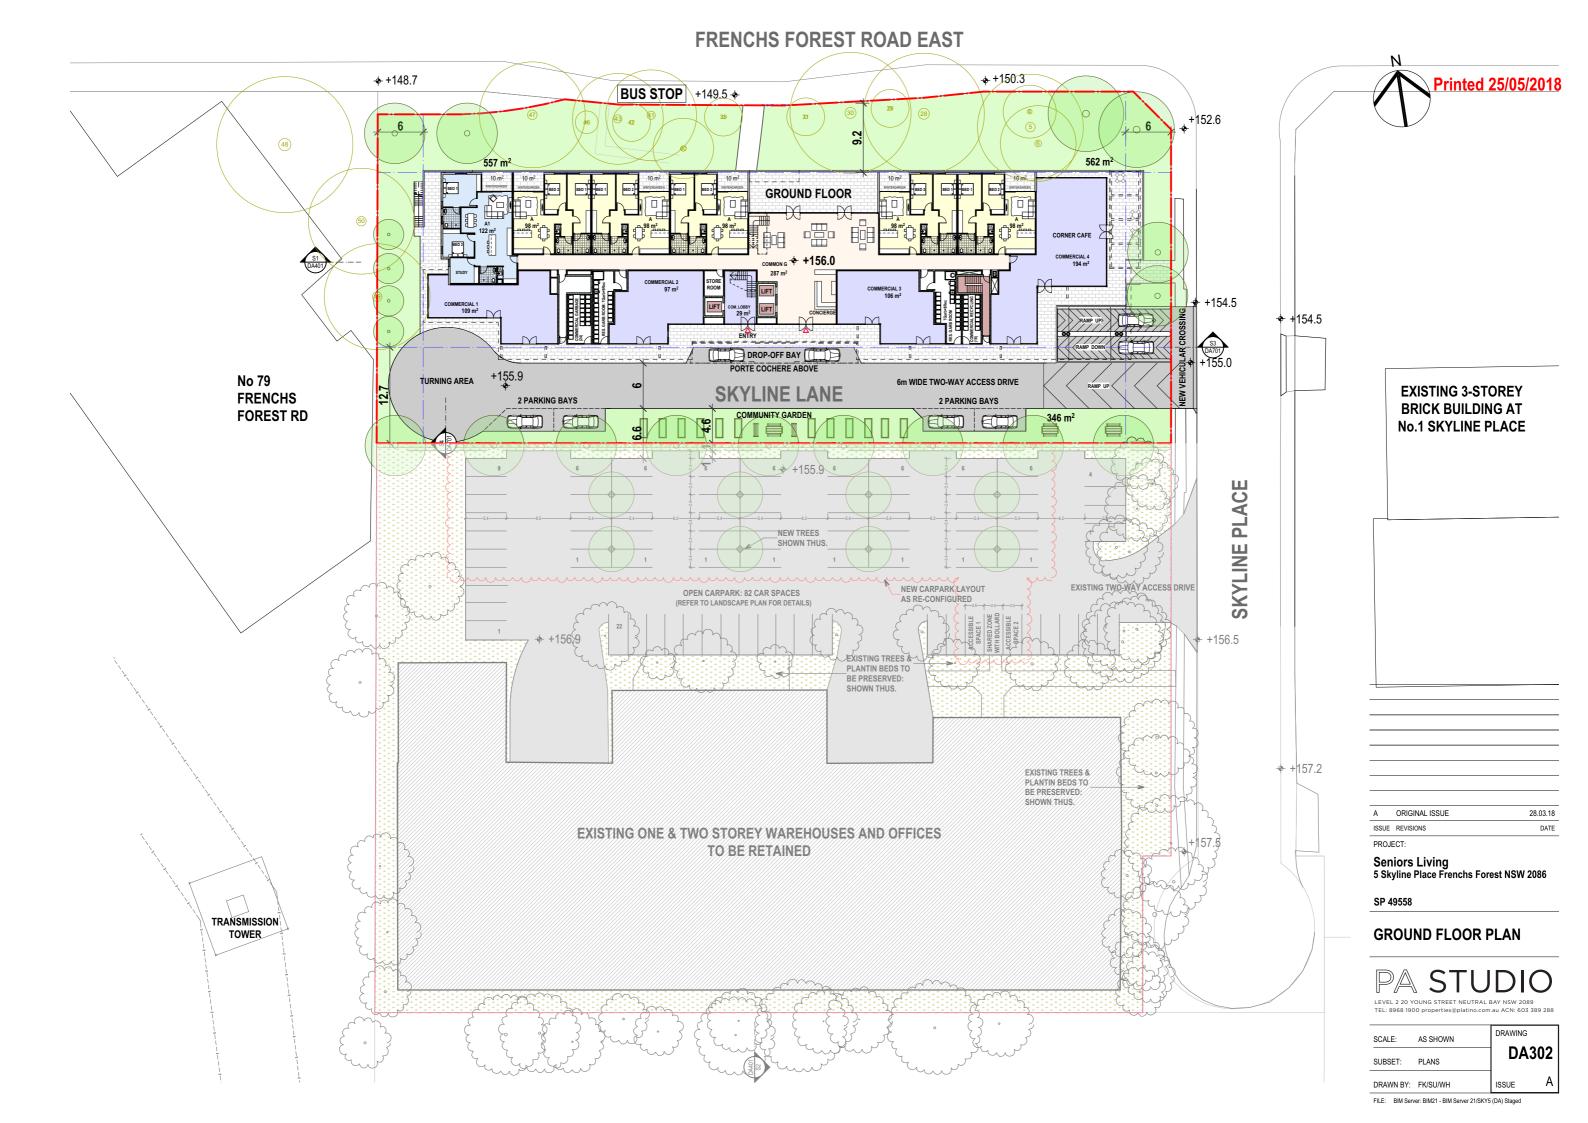

SCALE:	AS SHOWN	DRAWING
SUBSET:	PLANS	DA303
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Α	ORIGINAL ISSUE	28.03.18
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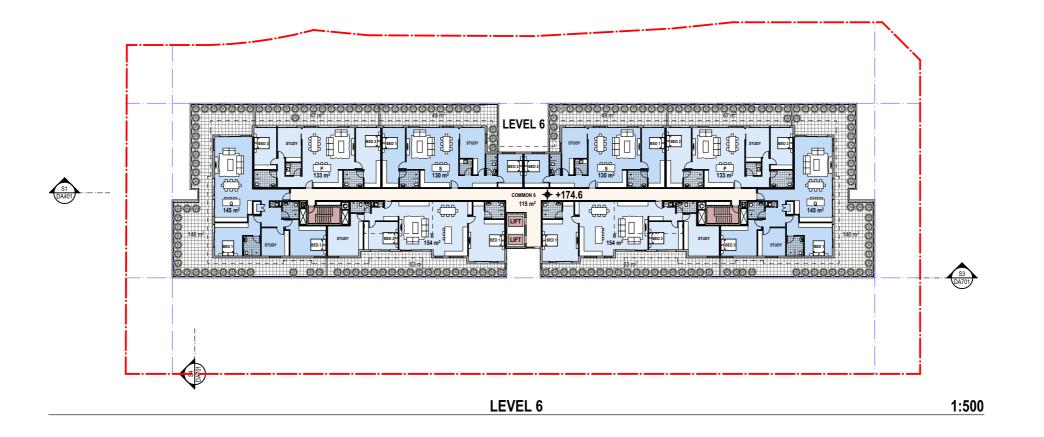
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## LEVELS 3 & 4 FLOOR PLANS

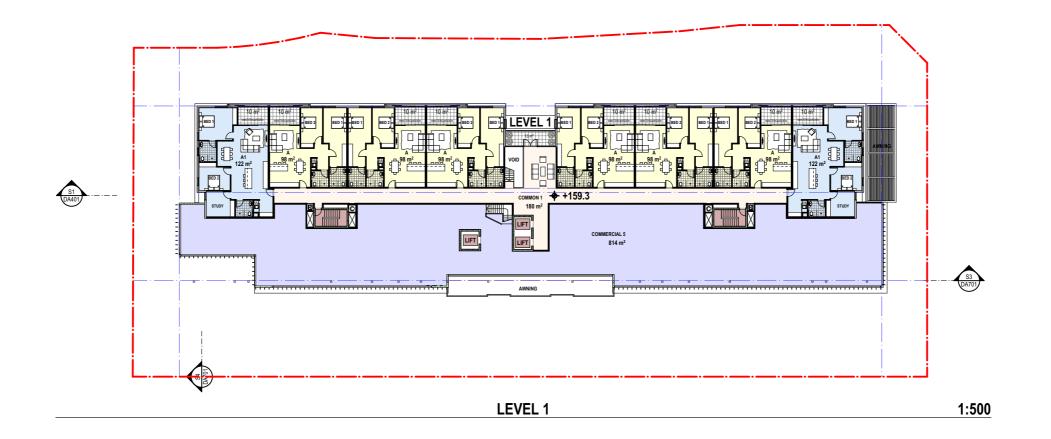


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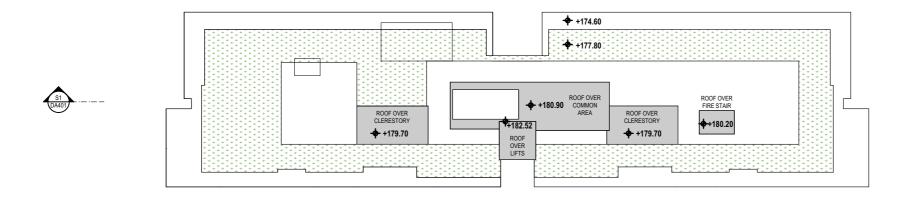
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## LEVELS 5 & 6 FLOOR PLANS

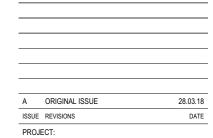


SCALE:	AS SHOWN	DRAWING
SUBSET:	PLANS	DA305
DRAWN BY:	FK/SU/WH	ISSUE A



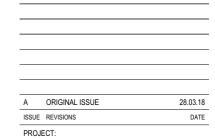

UPPER ROOF 1:500

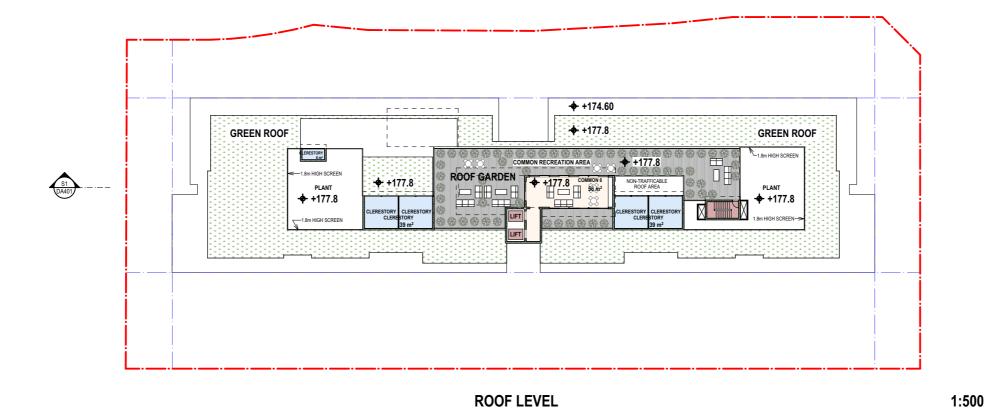

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PROJECT:
Seniors Living
5 Skyline Place Frenchs Forest NSW 2086


SP 49558


## **ROOF PLANS**




SCALE:	AS SHOWN	DRAWING	
		□   DA3	306
SUBSET:	PLANS	_	
DRAWN BY:	FK/SU/WH	ISSUE	Α



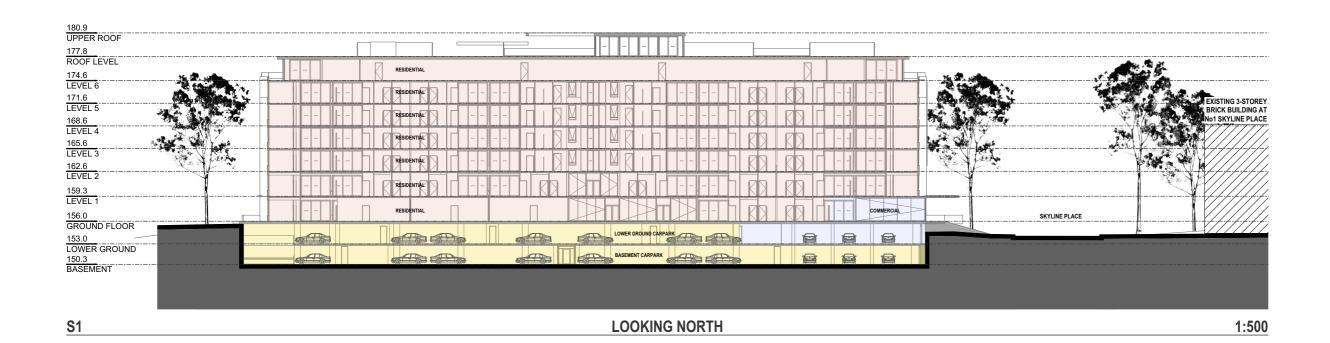

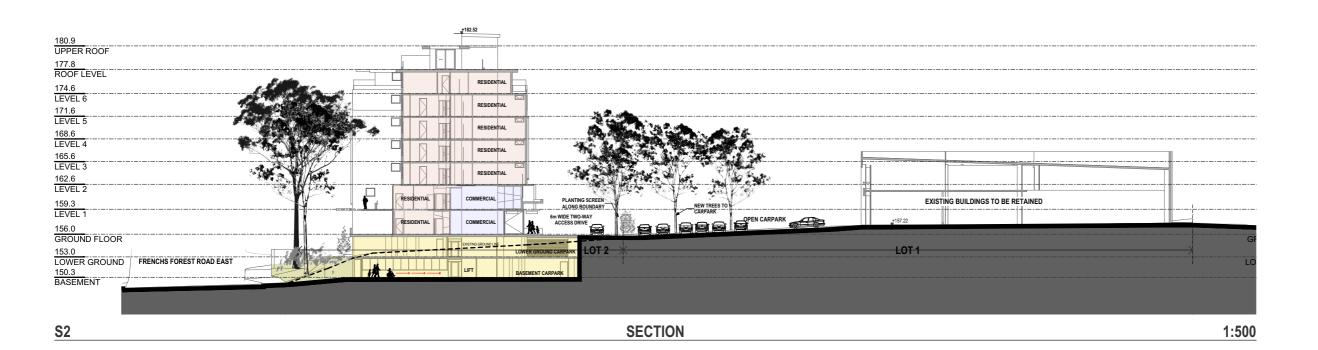

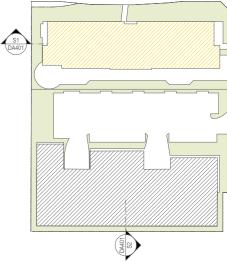

## KEY PLAN

Seniors Living 5 Skyline Place Frenchs Forest NSW 2086

SP 49558

## SECTIONS







E-01 NORTH ELEVATION CONTEXTUAL 1:500



E-01 NORTH ELEVATION 1:500

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PROJE	ECT:	
	iors Living yline Place Frenchs Fo	rest NSW 2086


### NORTH ELEVATION




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SUBSET:	ELEVATIONS	DA	501
DRAWN BY:	FK/SU/WH	ISSUE	Α





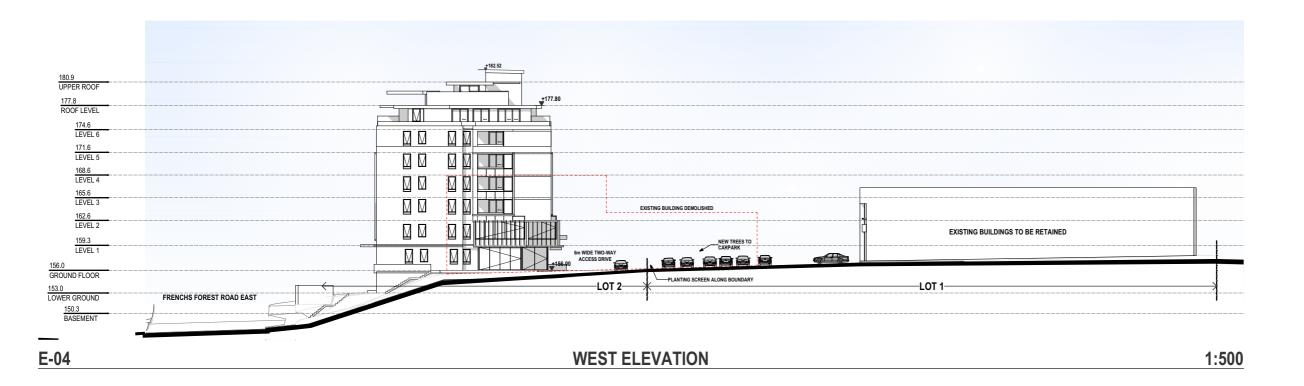

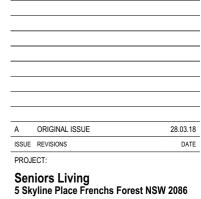


## WEST ELEVATION


SP 49558




SCALE:	AS SHOWN	DRAWING
SUBSET:	ELEVATIONS	DA502
DRAWN BY:	FK/SU/WH	ISSUE A



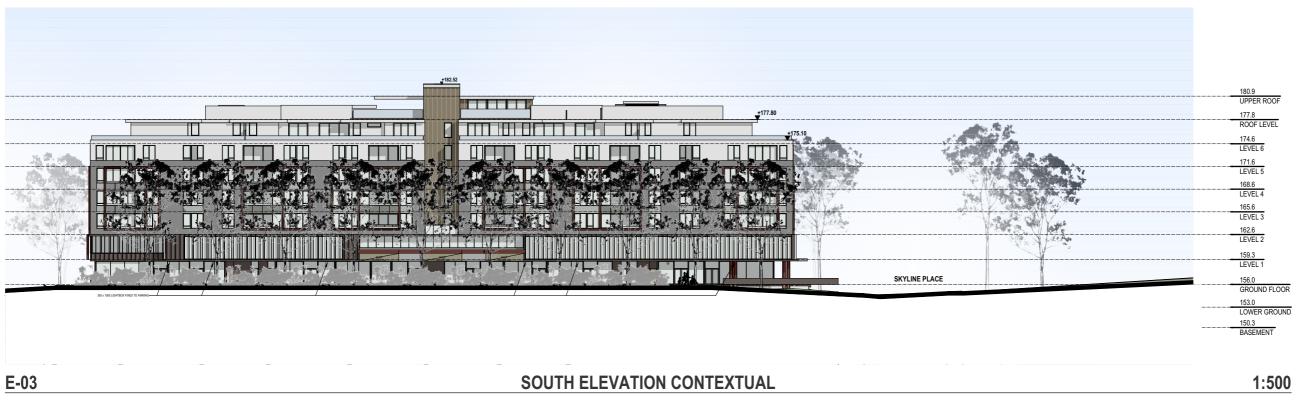


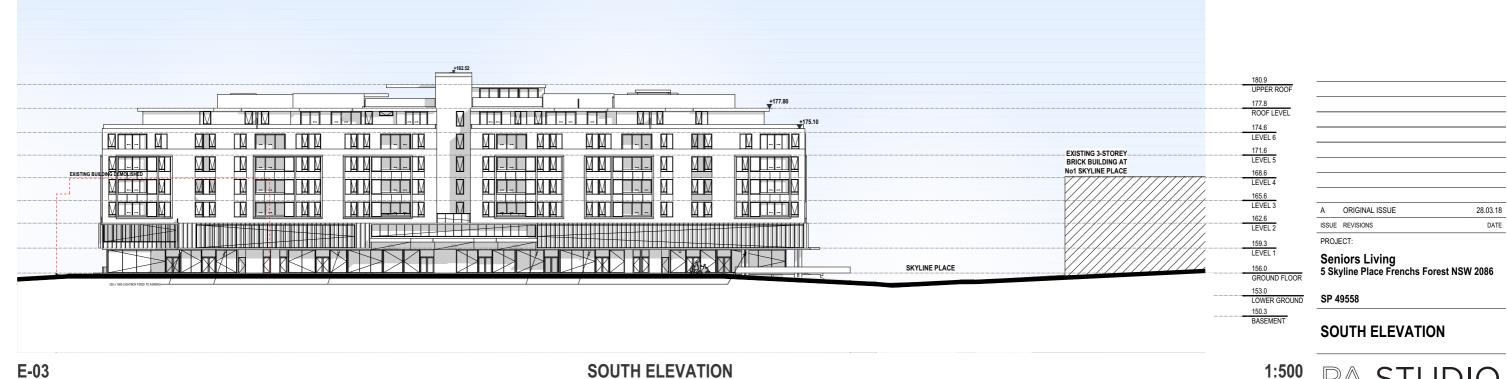

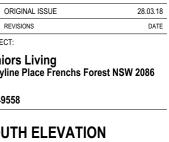


PA STUD LEVEL 2 20 YOUNG STREET NEUTRAL BAY NSW 2089 TEL: 8968 1900 properties@platino.com.au ACN: 603 389 288


SCALE:	AS SHOWN	DRAWING	
SUBSET:	ELEVATIONS	DA	503
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## EAST ELEVATION

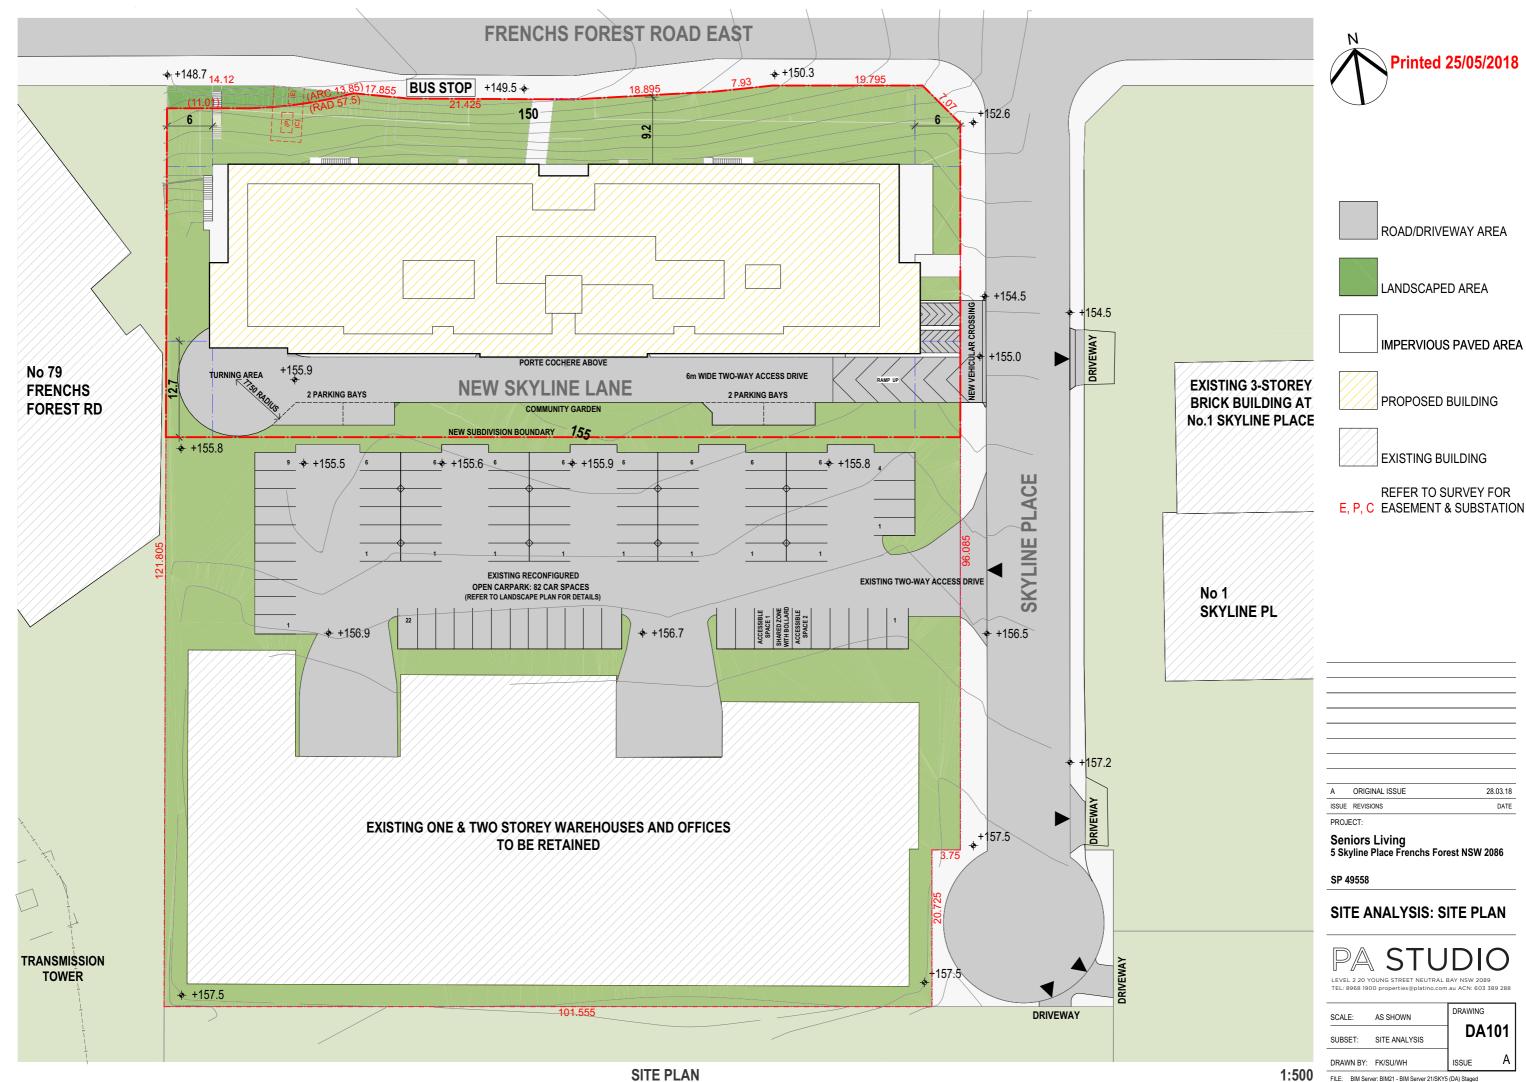SP 49558



SCALE:	AS SHOWN	DRAWING
SUBSET:	ELEVATIONS	DA504
DRAWN BY:	FK/SU/WH	ISSUE A

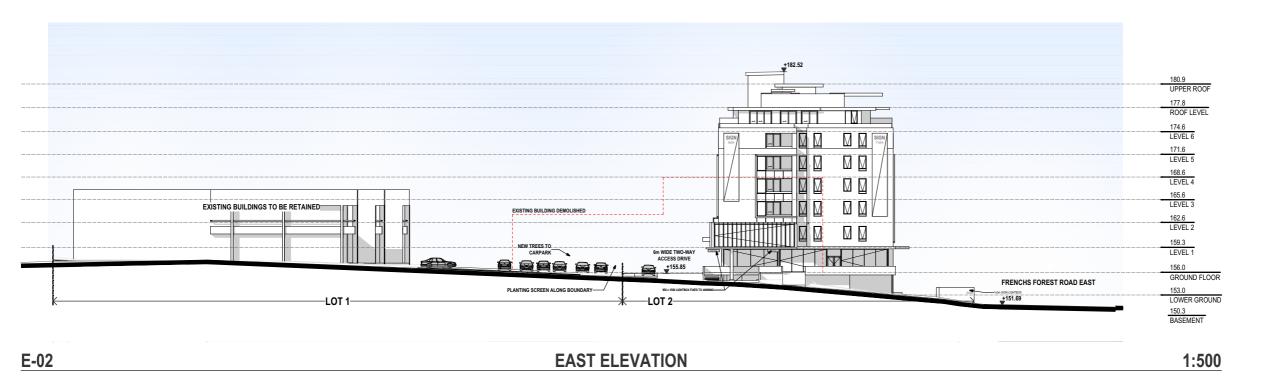

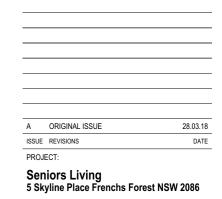

E-01 NORTH ELEVATION CONTEXTUAL 1:500

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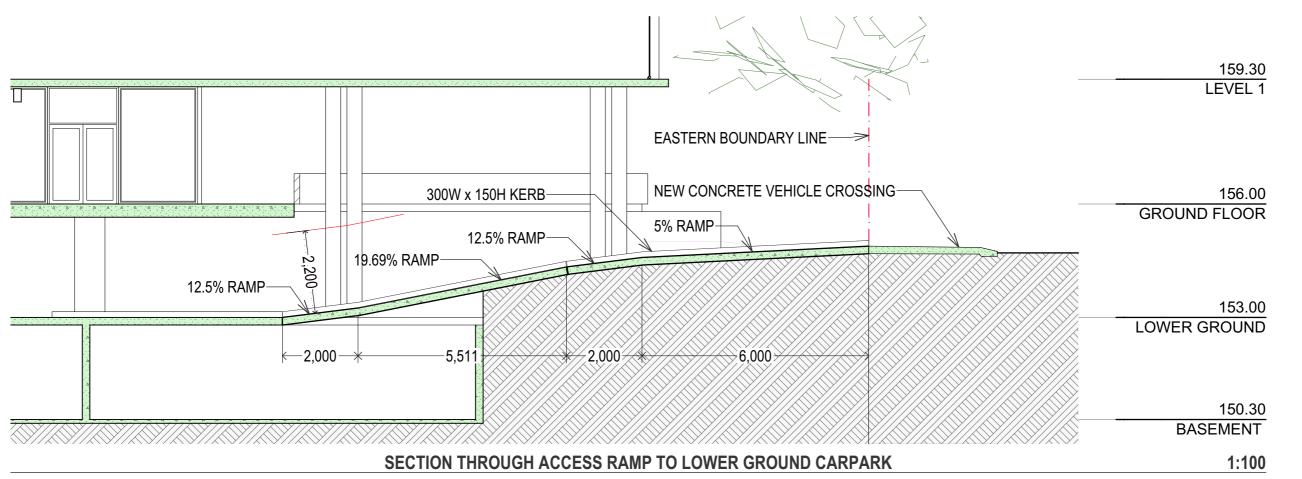
Seniors Living 5 Skyline Place Frenchs Forest NSW 2086

SP 49558


## MATERIALS AND FINISHES



SCALE:	AS SHOWN	DRAWING
SUBSET:	MATERIALS & FINISHES	DA601
DRAWN BY:	FK/SU/WH	ISSUE A





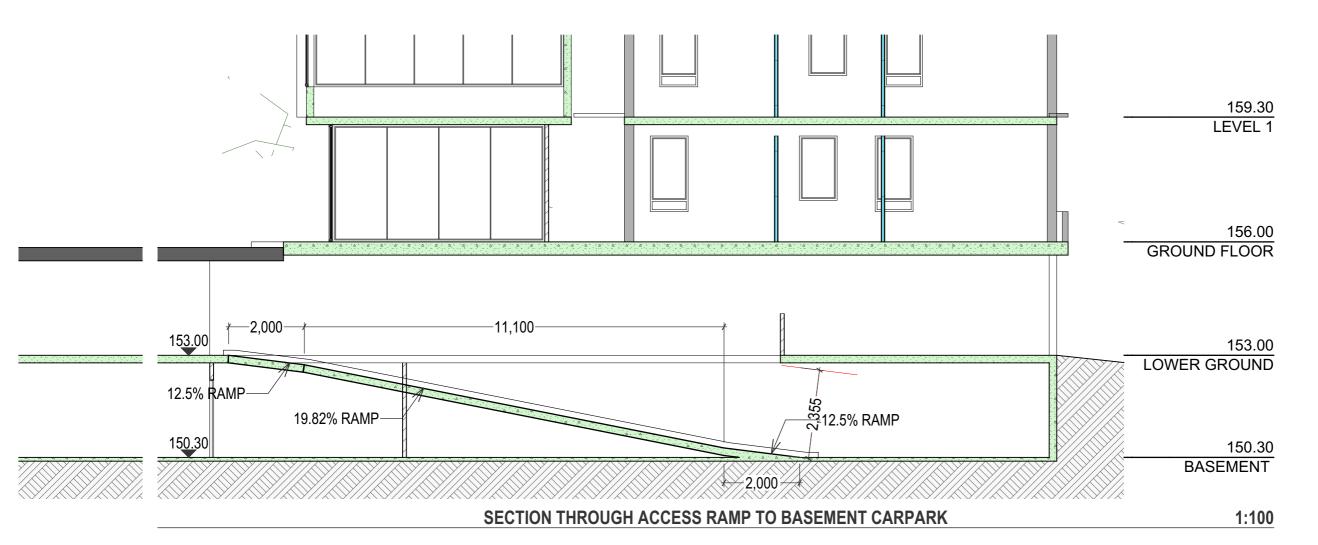

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PROJECT:

Seniors Living
5 Skyline Place Frenchs Forest NSW 2086


SP 49558

ACCESS RAMPS TO CARPARK: SECTIONS



SCALE:	AS SHOWN	DRAWING
SUBSET:	ACCESS RAMPS TO CARPARK	DA701
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## FRENCH FOREST ROAD EAST



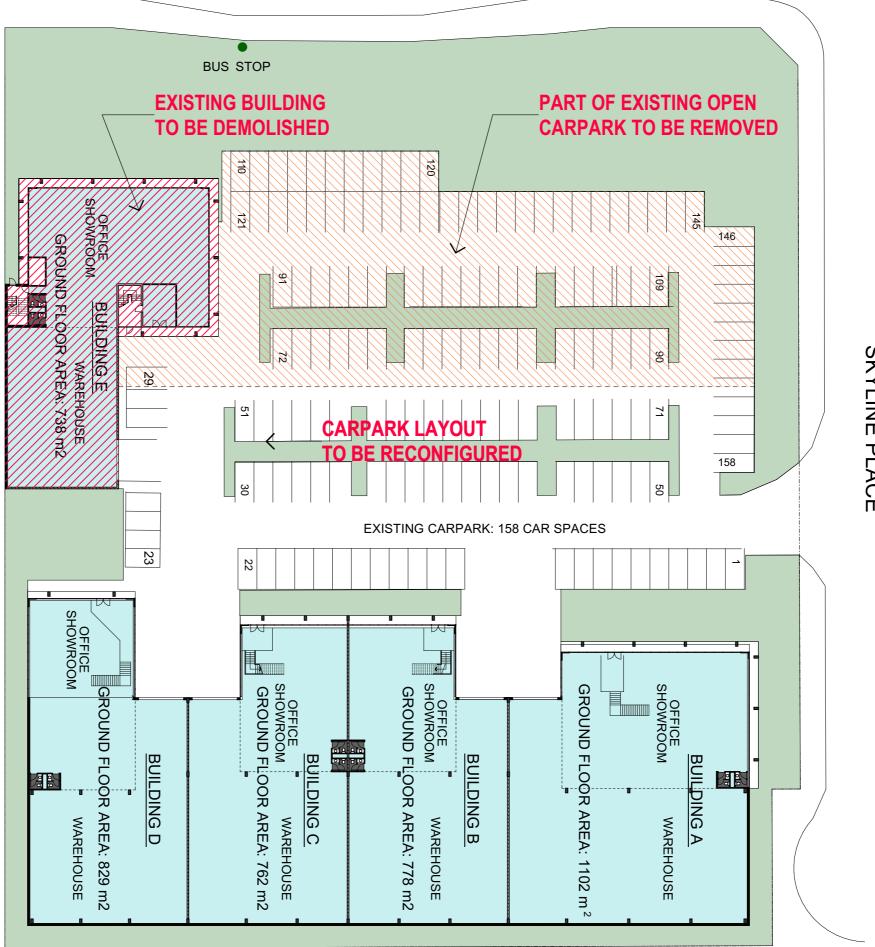

SKYLINE PLACE



## SP 49558



**DEMOLITION PLAN** 

SCALE:	AS SHOWN	DRAWING
SUBSET:	DEMOLITION	DA801
DRAWN BY:	FK/SU/WH	ISSUE A



### Multi Dwelling

Certificate number: 924670M

This certificate confirms that the proposed development will meet the NSW government's requirements for sustainability, if it is built in accordance with the commitments set out below. Terms used in this certificate, or in the commitments, have the meaning given by the document entitled "BASIX Definitions" dated 06/10/2017 published by the Department. This document is available at www.basix.nsw.gov.au

Secretary
Date of issue: Monday, 14 May 2018
To be valid, this certificate must be lodged within 3 months of the date of issue.



Project summary	
Project name	Seniors Living Skyline Place Frenchs F
Street address	5 Skyline Place Frenchs Forest 2086
Local Government Area	Northern Beaches Council
Plan type and plan number	strata 49558
Lot no.	Null
Section no.	-
No. of residential flat buildings	1
No. of units in residential flat buildings	78
No. of multi-dwelling houses	0
No. of single dwelling houses	0
Project score	
Water	✓ 40 Target 40
Thermal Comfort	✓ Pass Target Pa

Certificate Prepared by
Name / Company Name: Wood and Grieve Engineers
ABN (if applicable): 97137999609

BASIX	Planning & Environment	www.basix.nsw.gov.au	Version: 3.0 / DARWINIA_3_6_5	Certificate No.: 924670M	Monday, 14 May 2018	page

Project address	
Project name	Seniors Living Skyline Place Frenchs Forest
Street address	5 Skyline Place Frenchs Forest 2086
Local Government Area	Northern Beaches Council
Plan type and plan number	strata 49558
Lot no.	Null
Section no.	-
Project type	
No. of residential flat buildings	1
No. of units in residential flat buildings	78
No. of multi-dwelling houses	0
No. of single dwelling houses	0
Site details	
Site area (m²)	4786.5

**Description of project** 

Assessor details  Assessor number   VIC/13/1513  Zerificate number   LSOP/28EFMV  Zimate zone   56	
species (m²)           Assessor details           Assessor number         VIC/13/1513           Perificiate number         LSOP26EFMV           Dimate zone         56	
Certificate number LSOP26EFMV  Climate zone 56	
Certificate number LSOP26EFMV  Climate zone 56	
Climate zone 56	
Project score	
Water   ✓ 40 Tar	et 40
Thermal Comfort Pass Tar	et Pass
Energy    ✓ 28 Tan	et 25

Desc	rip	tion	of pro	oject																			
The tal	oles	below d	lescribe	the dw	ellings a	nd comr	non :	areas w	ithin the	e projec	t												
Resid	lent	ial fla	t build	linas -	Buildi	na1. 7	8 d\	vellin	as. 7 s	torev	s abov	e groui	nd										
Dwelling no.	No. of bedrooms	Conditioned floor area (m²)	Unconditioned floor area (m²)	Area of garden & lawn (m²)	Indigenous species (min area m²)	Dwelling no.	No. of bedrooms	Conditioned floor area (m²)	Unconditioned floor area (m²)	Area of garden & lawn (m²)	Indigenous species (min area m²)	Dwelling no.	No. of bedrooms	Conditioned floor area (m²)	Unconditioned floor area (m²)	Area of garden & lawn (m²)	Indigenous species (min area m²)	Dwelling no.	No. of bedrooms	Conditioned floor area (m²)	Unconditioned floor area (m²)	Area of garden & lawn (m²)	Indigenous species (min area m²)
101	3	118.2	0.0	0.0	0.0	102	2	94.0	0.0	0.0	0.0	103	2	93.7	0.0	0.0	0.0	104	2	91.7	0.0	0.0	0.0
105	2	91.7	0.0	0.0	0.0	106	2	94.0	0.0	0.0	0.0	107	2	93.7	0.0	0.0	0.0	108	3	118.2	0.0	0.0	0.0
201	3	118.2	0.0	0.0	0.0	202	2	94.0	0.0	0.0	0.0	203	2	93.7	0.0	0.0	0.0	204	3	104.6	0.0	0.0	0.0
205	3	104.6	0.0	0.0	0.0	206	2	93.7	0.0	0.0	0.0	207	2	94.0	0.0	0.0	0.0	208	3	118.2	0.0	0.0	0.0
209	3	127.2	0.0	0.0	0.0	210	2	99.7	0.0	0.0	0.0	211	3	112.7	0.0	0.0	0.0	212	3	112.7	0.0	0.0	0.0
213	2	99.7	0.0	0.0	0.0	214	3	127.2	0.0	0.0	0.0	301	3	118.2	0.0	0.0	0.0	302	2	94.0	0.0	0.0	0.0
303	2	93.7	0.0	0.0	0.0	304	3	104.6	0.0	0.0	0.0	305	3	104.6	0.0	0.0	0.0	306	2	93.7	0.0	0.0	0.0
307	2	94.0	0.0	0.0	0.0	308	3	118.2	0.0	0.0	0.0	309	2	127.2 99.7	0.0	0.0	0.0	310	2	99.7	0.0	0.0	0.0
401	3	112.7	0.0	0.0	0.0	402	2	94.0	0.0	0.0	0.0	403	2	99.7	0.0	0.0	0.0	404	3	104.6	0.0	0.0	0.0
401	3	104.6	0.0	0.0	0.0	402	2	93.7	0.0	0.0	0.0	407	2	94.0	0.0	0.0	0.0	404	3	118.2	0.0	0.0	0.0
409	3	127.2	0.0	0.0	0.0	410	2	99.7	0.0	0.0	0.0	411	3	112.7	0.0	0.0	0.0	412	3	112.7	0.0	0.0	0.0
413	2	99.7	0.0	0.0	0.0	414	3	127.2	0.0	0.0	0.0	501	3	118.2	0.0	0.0	0.0	502	2	94.0	0.0	0.0	0.0
503	2	93.7	0.0	0.0	0.0	504	3	101.7	0.0	0.0	0.0	505	3	101.7	0.0	0.0	0.0	506	2	93.7	0.0	0.0	0.0
507	2	94.0	0.0	0.0	0.0	508	3	118.2	0.0	0.0	0.0	509	3	127.2	0.0	0.0	0.0	510	2	99.7	0.0	0.0	0.0
511	3	112.7	0.0	0.0	0.0	512	3	112.7	0.0	0.0	0.0	513	2	99.7	0.0	0.0	0.0	514	3	127.2	0.0	0.0	0.0
601	3	152.2	0.0	0.0	0.0	602	3	142.4	0.0	0.0	0.0	603	3	128.2	0.0	0.0	0.0	604	3	126.8	0.0	0.0	0.0
605	3	126.8	0.0	0.0	0.0	606	3	128.2	0.0	0.0	0.0	607	3	142.4	0.0	0.0	0.0	608	3	152.2	0.0	0.0	0.0

Dwelling no.	No. of bedrooms	Conditioned floor area (m²)	Unconditioned floor area (m²)	Area of garden & lawn (m²)	Indigenous species (min area m²)	Dwelling no.	No. of bedrooms	ditioned a (m²)	Unconditioned floor area (m²)	Area of garden & lawn (m²)	Indigenous species (min area m²)	Dwelling no.	No. of bedrooms	Conditioned floor area (m²)	Unconditioned floor area (m²)	Area of garden & lawn (m²)	Indigenous species (min area m²)	Dwelling no.	No. of bedrooms	Conditioned floor area (m²)	Unconditioned floor area (m²)	Area of garden & lawn (m²)	Indigenous species (min area m²)
G01	3	118.2	0.0	0.0	0.0	G02	2	94.0	0.0	0.0	0.0	G03	2	93.7	0.0	0.0	0.0	G04	2	91.7	0.0	0.0	0.0
G05	2	93.7	0.0	0.0	0.0	G06	2	94.0	0.0	0.0	0.0												

### Description of project

Common areas of unit building - Building1

Common area	Floor area (m²)	Common area	Floor area (m²)
Car park area (Lower Ground)	2608.0	Car park area (Basement)	2535.0
Lift car (No.2)	-	Lift car (No.3)	-
Store Room	9.0	Fire Stairs	156.0
Hallway/lobby type (Residential)	1048.0		

### Schedule of BASIX commitments

1. Commitments for Residential flat buildings - Building1

(b) Common areas and central systems/facilities (i) Water (ii) Energy

3. Commitments for single dwelling houses

(i) Water (ii) Energy

### Schedule of BASIX commitments

The commitments set out below regulate how the proposed development is to be carried out. It is a condition of any development consent granted, or complying development certificate issued, for the proposed development, that BASIX commitments be complied with.

### 1. Commitments for Residential flat buildings - Building1

(i) Water	Show on DA plans	Show on CC/CDC plans & specs	Certifier check
(a) The applicant must comply with the commitments listed below in carrying out the development of a dwelling listed in a table below.			
(b) The applicant must plant indigenous or low water use species of vegetation throughout the area of land specified for the dwelling in the "Indigenous species" column of the table below, as private landscaping for that dwelling. (This area of indigenous vegetation is to be contained within the "Area of garden and lawn" for the dwelling specified in the "Description of Project" table).	~	~	
(c) If a rating is specified in the table below for a fixture or appliance to be installed in the dwelling, the applicant must ensure that each such fixture and appliance meets the rating specified for it.		~	~
(d) The applicant must install an on demand hot water recirculation system which regulates all hot water use throughout the dwelling, where indicated for a dwelling in the "HW recirculation or diversion" column of the table below.		~	•
(e) The applicant must install:			
(aa) a hot water diversion system to all showers, kitchen sinks and all basins in the dwelling, where indicated for a dwelling in the "HW recirculation or diversion" column of the table below; and		_	•
(bb) a separate diversion tank (or tanks) connected to the hot water diversion systems of at least 100 litres. The applicant must connect the hot water diversion tank to all toilets in the dwelling.		_	•
(e) The applicant must not install a private swimming pool or spa for the dwelling, with a volume exceeding that specified for it in the table below.	~	~	
(f) If specified in the table, that pool or spa (or both) must have a pool cover or shading (or both).		~	
(g) The pool or spa must be located as specified in the table.	~	~	
(b) The applicant must install, for the dwelling, each alternative water supply system, with the specified size, listed for that dwelling in the table below. Each system must be configured to collect run-off from the areas specified (excluding any area which supplies any other alternative water supply system), and to divert overflow as specified. Each system must be connected as specified.	~	~	~


			Fixtur	es		Appli	ances		Indi	vidual pool		In	dividual	spa
Dwelling no.	All shower- heads	All toilet flushing systems	kitchen	All bathroom taps	HW recirculation or diversion	All clothes washers	All dish- washers	Volume (max volume)	Pool cover	Pool location	Pool shaded	Volume (max volume)	Spa cover	Spa shaded
All dwellings	3 star (> 4.5 but <= 6 L/min)	4 star	6 star	6 star	-	-	3 star	-	-	-	-	-	-	-

			Alternative water se						
Dwelling no.	Alternative water supply systems	Size	Configuration	Landscape connection	Toilet connect (s)		Laundry connectio	Pool top-up	Spa top-up
None	-	-	-	-	-		-	-	-
(ii) Energy						Show DA pi		now on CC/CDC ans & specs	Certifier check
(b) The applic supplied b	(a) The applicant must comply with the commitments issed below in carrying out the development of a dwelling listed in a table below.  (b) The applicant must install agen hot water system specified for the dwelling in the table below, so that the dwelling is hot water is supplied by that system. If the table specifies a central hot water system for the dwelling, to the the dwelling, to that the dwelling is not water is supplied by that central system to the dwelling, to that the dwelling is not water is supplied by that central system.								
			d laundry of the dwelling, the ventilation system s the operation control specified for it in the table.		oom in			~	~
areas" hea no cooling any such a	adings of the "Cooling" and " or heating system is specifi areas. If the term "zoned" is:	Heating" columns ed in the table for specified beside:	m/s specified for the dwelling under the "Living ar s in the table below, in/for at least 1 living/bedroon "Living areas" or "Bedroom areas", then no syste an air conditioning system, then the system must p	n area of the dwe ms may be instal	lling. If led in			•	~
the table b lighting" fo specified f	elow (but only to the extent ir each such room in the dwe or a particular room or area,	specified for that alling is fluoresce then the light fitt	room or area). The applicant must ensure that the nt lighting or light emitting diode (LED) lighting. If t ings in that room or area must only be capable of l	zoning between living areas and bedrooms.  (a) This commitment applies to each from our carea of the dwelling which is referred to in a heading to the "Antificial lighting" column of the table below (but only to the extent specified for that room or area). The applicant must ensure that the "primary type of antificial lighting" for each such room in the dwelling is fluorescent lighting of light girls. But my "decidated" is specified for a particular room or area, then the light fittings in that room or area amust only be capable of being used for fluorescent lighting or light emitting dode (LED) lighting.					

(ii) Energy	Show on DA plans	Show on CC/CDC plans & specs	Certifier check
(f) This commitment applies to each room or area of the dwelling which is referred to in a heading to the "Natural lighting" column of the table below (but only to the extent specified for that room or area). The applicant must ensure that each such room or area is fitted with a window and/or skylight.	~	~	~
(g) This commitment applies if the applicant installs a water heating system for the dwelling's pool or spa. The applicant must:			
(aa) install the system specified for the pool in the "Individual Pool" column of the table below (or alternatively must not install any system for the pool). If specified, the applicant must install a timer, to control the pool's pump; and		•	
(bb) install the system specified for the spa in the "Individual Spa" column of the table below (or alternatively must not install any system for the spa). If specified, the applicant must install a timer to control the spa's pump.		•	
(h) The applicant must install in the dwelling:			
<ul><li>(aa) the kitchen cook-top and oven specified for that dwelling in the "Appliances &amp; other efficiency measures" column of the table below;</li></ul>		-	
(bb) each appliance for which a rating is specified for that dwelling in the "Appliances & other efficiency measures" column of the table, and ensure that the appliance has that minimum rating; and		•	•
(cc) any clothes drying line specified for the dwelling in the "Appliances & other efficiency measures" column of the table.		-	
<ul> <li>(i) If specified in the table, the applicant must carry out the development so that each refrigerator space in the dwelling is "well ventilated".</li> </ul>		_	

	Hot water	Bathroom ventilation system		Kitchen venti	lation system	Laundry ventilation system		
Dwelling no.	Hot water system	Each bathroom	Operation control	Each kitchen	Operation control	Each laundry	Operation control	
All dwellings	central hot water system 1	individual fan, ducted to façade or roof	manual switch on/off	individual fan, ducted to façade or roof	manual switch on/off	individual fan, ducted to façade or roof	manual switch on/off	

	Coo	ling	Hea	iting			Artificial	lighting			Natural lig	hting
Dwelling no.	living areas	bedroom areas	living areas	bedroom areas	No. of bedrooms &/or study	No. of living &/or dining rooms	Each kitchen	All bathrooms/ toilets	Each laundry	All hallways	No. of bathrooms &/or toilets	Main kitcher
102. 103. 104. 105. 106. 107. 202. 203. 206. 207. 210. 302. 303. 306. 307. 313. 3402. 403. 4403. 4403. 4403. 502. 503. 506. 507. 510. 513. 602. 603. 606.	1-phase airconditioning EER 3.0 - 3.5		1-phase airconditioning EER 3.0 - 3.5		2 (dedicated)	1 (dedicated)	yes (dedicated)	yes (dedicated)	yes (dedicated)	yes (dedicated)	O	-
All other dwellings	1-phase airconditioning EER 3.0 - 3.5	3 (dedicated)	1 (dedicated)	yes (dedicated)	yes (dedicated)	yes (dedicated)	yes (dedicated)	0	-			

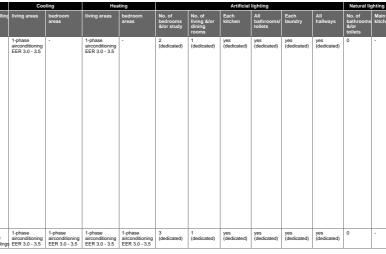

(iii) Therr	mal Comfort								Show or DA plan	ow on CC/CDC	Certifie
"Ass	applicant must attach sessor Certificate") to applicant is applying t at also attach the Asse	the devel or a comp	opment application olying development	and const certificate	ruction certificate a for the proposed of	application for the development, to t	proposed de hat application	evelopment (or, if n). The applicant		<u> </u>	
(b) The	Assessor Certificate	must have	e been issued by an	Accredite	ed Assessor in acc	ordance with the	Thermal Con	nfort Protocol.			
	details of the propose tificate, including the					istent with the de	tails shown in	this BASIX			
whic	applicant must show the Thermal Comfo	ort Protoc		own on the					~		
the A	Accredited Assessor,	to certify	triat trits is trie case	-							
(e) The certif	applicant must show ificate, if applicable), elopment which were	on the pla	ans accompanying to	he applica						~	
(e) The certification (f) The a Certification (f) The and the cert	applicant must show ificate, if applicable),	on the pla all therma used to c uct the de ance with	ans accompanying to all performance special culate those special evelopment in accorrections aspects of the	he applications sifications.  dance with a develop	set out in the Asset	ssor Certificate, a	and all aspect	s of the proposed		<b>y</b>	•

		Thermal loads
Dwelling no.	Area adjusted heating load (in mJ/m²/yr)	Area adjusted cooling load (in mJ/m²/yr)
101	2.1	21.7
102	3.3	13.1
103	2.5	17.4
104	7.4	13.7
105	33.6	17.3
106	3.4	13.3
107	2.7	15.6
108	2.8	21.6
201	2.6	20.0
202	3.8	12.6
203	2.9	16.4
204	3.2	22.2
205	3.1	22.5
206	3.1	14.8
207	3.9	12.6
208	3.3	20.5
209	17.4	15.1
210	25.5	12.5
211	26.6	12.9
212	27.7	12.8
213	25.7	12.3
214	22.4	13.6
304	3.6	21.4
305	3.4	20.7
404	3.8	20.3
405	3.6	20.2
501	6.3	20.1

		Thermal loads
Dwelling no.	Area adjusted heating load (in mJ/m²/yr)	Area adjusted cooling load (in mJ/m²/yr)
502	5.7	11.8
503	4.5	16.0
504	5.2	20.7
505	4.5	19.2
506	4.7	14.4
507	5.7	11.9
508	7.2	20.0
509	24.1	14.7
510	29.8	12.9
511	29.6	12.6
512	30.7	12.8
513	30.0	12.9
514	24.6	14.2
601	36.7	13.2
602	24.7	27.2
603	21.1	20.0
604	18.3	21.2
605	18.2	20.7
606	21.2	20.0
607	21.2	21.2
608	39.2	14.7
G01	6.5	17.0
G02	8.2	10.5
G03	5.7	14.2
G04	14.1	11.7
G05	9.0	13.4
G06	8.3	10.7



	ORIGINAL ISSUE	28.03.18
SUE	REVISIONS	DATE
ROJI	ECT:	

Seniors Living 5 Skyline Place Frenchs Forest NSW 2086

SP 49558

## **BASIX COMMITMENTS -1**



SCALE:	AS SHOWN	DRAWING
SUBSET:	BASIX COMMITMENTS	DA901
DRAWN BY:	FK/SU/WH	ISSUE A

	Thermal loads				
Dwelling no.	Area adjusted heating load (in mJ/m²/yr)	Area adjusted cooling load (in mJ/m²/yr)			
01, 401	2.9	18.9			
802, 402	4.0	12.0			
803, 403	3.2	15.8			
06, 406	3.5	14.1			
07, 407	4.2	11.9			
808, 408	3.7	19.4			
09, 409	18.1	14.3			
10, 410	26.3	12.2			
311, 411	26.9	12.5			
312, 412	28.1	12.5			
13, 413	26.5	12.1			
II other dwellings	16.6	14.0			

Central energy systems	Туре	Specification
Central hot water system (No. 1)	gas instantaneous	Piping insulation (ringmain & supply risers): (a) Piping external to building: R0.6 (-25 mm); (b) Piping internal to building: R0.6 (-25 mm)
Lift (No. 1)	gearless traction with V V V F motor	Number of levels (including basement): 9
Lift (No. 2)	gearless traction with V V V F motor	Number of levels (including basement): 9
Lift (No. 3)	gearless traction with V V V F motor	Number of levels (including basement): 4

Central energy systems	Туре	Specification
Central hot water system (No. 1)	gas instantaneous	Piping insulation (ringmain & supply risers): (a) Piping external to building: R0.6 (-25 mm); (b) Piping internal to building: R0.6 (-25 mm)
Lift (No. 1)	gearless traction with V V V F motor	Number of levels (including basement): 9
ift (No. 2)	gearless traction with V V V F motor	Number of levels (including basement): 9
Lift (No. 3)	gearless traction with V V V F motor	Number of levels (including basement): 4



### (b) Common areas and central systems/facilities

(i) Water	Show on DA plans	Show on CC/CDC plans & specs	Certifier check
(a) If, in carrying out the development, the applicant installs a showerhead, toilet, tap or clothes washer into a common area, then that item must meet the specifications listed for it in the table.		~	~
(b) The applicant must install (or ensure that the development is serviced by) the alternative water supply system(s) specified in the 'Central systems' column of the table below. In each case, the system must be sized, be configured, and be connected, as specified in the table.	~	~	~
(c) A swimming pool or spa listed in the table must not have a volume (in kLs) greater than that specified for the pool or spa in the table.	•	~	
(d) A pool or spa listed in the table must have a cover or shading if specified for the pool or spa in the table.		~	
(e) The applicant must install each fire sprinkler system listed in the table so that the system is configured as specified in the table.		~	~
(f) The applicant must ensure that the central cooling system for a cooling tower is configured as specified in the table.		~	~

Common area S	Showerheads rating	Toilets rating	Taps rating	Clothes washers rating
All common nareas	no common facility	no common facility	no common facility	no common laundry facility

Central systems	Size	Configuration	Connection (to allow for)
Central water tank - rainwater or stormwater (No. 1)	1000.0	To collect run-off from at least: - 888.5 square metres of roof area of buildings in the development - 0.0 square metres of impervious area in the development - 0.0 square metres of garden/lawn area in the development - 0.0 square metres of plante box area in the development (excluding, in each case, any area which drains to, or supplies, any other alternative water supply system).	- irrigation of 995.0 square metres of common landscaped area on the site - car washing in 0 car washing bays on the site
Fire sprinkler system (No. 1)	-		-

(ii) Energy	Show on DA plans	Show on CC/CDC plans & specs	Certifier check
(a) If, in carrying out the development, the applicant installs a ventilation system to service a common area specified in the table below, then that ventilation system must be of the type specified for that common area, and must meet the efficiency measure specified.		~	~
(b) In carrying out the development, the applicant must install, as the "primary type of artificial lighting" for each common area specified in the table below, the lighting specified for that common area. This lighting must meet the efficiency measure specified. The applicant must alian install a centralised lighting control system or Building Management System (BMS) for the common area, where specified.		~	~
(c) The applicant must install the systems and fixtures specified in the "Central energy systems" column of the table below. In each case, the system or fixture must be of the type, and meet the specifications, listed for it in the table.	~	~	~

Common area ventilation system			Common area lighting		
Common area	Ventilation system type	Ventilation efficiency measure	Primary type of artificial lighting	Lighting efficiency measure	Lighting control system/BMS
Car park area (Lower Ground)	ventilation (supply + exhaust)	carbon monoxide monitor + VSD fan	compact fluorescent	none	Yes
Car park area (Basement)	ventilation (supply + exhaust)	carbon monoxide monitor + VSD fan	compact fluorescent	none	Yes
Lift car (No.1)	-	-	light-emitting diode	connected to lift call button	Yes
Lift car (No.2)	-	-	light-emitting diode	connected to lift call button	Yes
Lift car (No.3)	-	-	light-emitting diode	connected to lift call button	Yes
Garbage room (Residential)	ventilation exhaust only	-	compact fluorescent	manual on / manual off	No
Store Room	no mechanical ventilation	-	compact fluorescent	manual on / manual off	No
Fire Stairs	no mechanical ventilation		compact fluorescent	motion sensors	No
Ground floor lobby type	no mechanical ventilation	-	light-emitting diode	none	Yes
Hallway/lobby type (Residential)	no mechanical ventilation	-	light-emitting diode	none	Yes

\*\*\*\*

HOUSE

### 4. Commitments for common areas and central systems/facilities for the development (non-building specific)

(i) Water	Show on DA plans	Show on CC/CDC plans & specs	Certifier check
(a) If, in carrying out the development, the applicant installs a showerhead, toilet, tap or clothes washer into a common area, then that item must meet the specifications listed for it in the table.		~	~
(b) The applicant must install (or ensure that the development is serviced by) the alternative water supply system(s) specified in the Central systems column of the table below. In each case, the system must be sized, be configured, and be connected, as specified in the table.	~	~	~
(c) A swimming pool or spa listed in the table must not have a volume (in kLs) greater than that specified for the pool or spa in the table.	V	~	
(d) A pool or spa listed in the table must have a cover or shading if specified for the pool or spa in the table.		~	
(e) The applicant must install each fire sprinkler system listed in the table so that the system is configured as specified in the table.		~	~
(f) The applicant must ensure that the central cooling system for a cooling tower is configured as specified in the table.		~	~

areas	no continion facility	no continion facility	no continion facility	no common aum	ary racinty	
(ii) Energy				Show on DA plans	Show on CC/CDC plans & specs	Certifier check
	g out the development, the applicant in that ventilation system must be of the				~	~
specified in t	nt must also install a centralised lightin	or that common area. This lighting mu	al lighting" for each common area st meet the efficiency measure specific ent System (BMS) for the common are		•	~
	nt must install the systems and fixtures stem or fixture must be of the type, an		ms" column of the table below. In each the table.	•	~	~

- 2. The applicant must identify each dwelling, building and common area listed in this certificate, on the plans accompanying any development application, and on the plans and specifications accompanying the application for a construction certificate! complying development certificate, for the proposed development, using the same identifying letter or reference as is given to that dwelling, building or common area in this certificate.
- The most packed to the control of th

- 5. If a star or other rating is specified in a commitment, this is a minimum rating.

  6. All alternative water systems to be installed under these commitments (if any), must be installed in accordance with the requirements of all applicable regulatory authorities. NOTE:
  NSW Health does not recommend that showmarder, recycled water or private dam water be used to imigate edible plants which are consumed raw, or that nairwater be used for
  human consumption in areas with potable water supplies.

- 1. Commitments identified with a 🚧 in the "Show on DA plans" column must be shown on the plans accompanying the development application for the proposed development (if a
- Commitments identified with a "y" in the "Chow on CCCDC plans and specs" column must be shown in the plans and specifications accompanying the application for a construction certificate / complying development certificate for the proposed development.

  3. Commitments identified with a "y" in the "Certifier check" column must be certified by a certifying authority as having been fulfilled. (Note: a certifying authority must not issue an occupation certificate (either interine or final) for a building fasted in this certificate, or for any part of such a building, unless it is satisfied that each of the commitments whose fulfillment it is required to monitor in relation to the building or part, has been fulfilled).

### 4. Commitments for common areas and central systems/facilities for the development (non-building specific)

### (b) Common areas and central systems/facilities

(i) Water	Show on DA plans	Show on CC/CDC plans & specs	Certifier check
(a) If, in carrying out the development, the applicant installs a showerhead, toilet, tap or clothes washer into a common area, then that item must meet the specifications listed for it in the table.		~	~
(b) The applicant must install (or ensure that the development is serviced by) the alternative water supply system(s) specified in the "Central systems" column of the table below. In each case, the system must be sized, be configured, and be connected, as specified in the table.	~	~	~
(c) A swimming pool or spa listed in the table must not have a volume (in kLs) greater than that specified for the pool or spa in the table.	~	~	
(d) A pool or spa listed in the table must have a cover or shading if specified for the pool or spa in the table.		~	
(e) The applicant must install each fire sprinkler system listed in the table so that the system is configured as specified in the table.		~	~
(f) The applicant must ensure that the central cooling system for a cooling tower is configured as specified in the table.		~	~

areas	no common facility	no common facility	no common facility	no common launo	iry raciiry			
(ii) Energy		Show on DA plans	Show on CC/CDC plans & specs	Certifier check				
(a) If, in carrying out the development, the applicant installs a ventilation system to service a common area specified in the table below, then that ventilation system must be of the type specified for that common area, and must meet the efficiency measure specified.					~	~		
(b) is carying out the development, the applicant must install, as the "primary type of antificial lighting" for each common area specified in the table below, he lighting specified for that common area. This lighting must need the efficiency measure specified. The applicant must also install a centralised lighting control system or Building Management System (BMS) for the common area, where specified.					~	~		
	nt must install the systems and fixtures istem or fixture must be of the type, an			_				

- 2. The applicant must identify each dwelling, building and common area listed in this certificate, on the plans accompanying any development application, and on the plans and specifications accompanying the application for a construction certificate! complying development certificate, for the proposed development, using the same identifying letter or reference as is given to that dwelling, building or common area in this certificate.
- revenue. As a givent to that twening, counting or continual sets at 18th CRITICISE.

  A. This note applies if the proposed development involves the erection of a building for both residential and non-residential purposes (or the change of use of a building for both residential and non-residential purposes). Commitments in this certificate which are specified to apply to a "common area" of a building or the development, apply only to that part of the building or development and for residential purposes.

- No. It is atter or the rating is specified in a commitment, this is a minimum rating.

   All alternative water systems to be installed under these commitments (if any), must be installed in accordance with the requirements of all applicable regulatory authorities. NOTE:
   NSW Health does not recommend that stormwater, recycled water or private dam water be used to irrigate edible plants which are consumed raw, or that rainwater be used for human consumption in areas with possible water supplies.

- 1. Commitments identified with a 💓 in the "Show on DA plans" column must be shown on the plans accompanying the development application for the proposed development (if a
- Commitments identified with a "y" in the "Show on CC/CDC plans and specs" column must be shown in the plans and specifications accompanying the application for a construction certificate / complying development certificate for the proposed development.

  3. Commitments identified with a "y" in the "Certifier check" column must be certified by a certifying authority as having been fulfilled. (Note: a certifying authority must not issue an occupation certificate (either interine or final) for a building listed in this certificate, or for any part of such a building, unless it is satisfied that each of the commitments whose fulfillment it is required to monitor in relation to the building or part, has been fulfilled).

## Nationwide House Energy Rating Scheme\* — Class 2 summary

Certificate Number: LSOP26EFMV Date of Certificate: 11 May 2018 ★ Average star rating: 7.7 HOUSE

## Assessor details Name: Nicholas Johnson Organisation: Wood & Grieve Engineers Email: nicholas Johnson@wge.com.au Phone: 0401702351 Declaration of interest: Softwar--

Software: FirstRate5 v5.2.8a AAO: BDAV

## Summary of all dwellings

## Certificate number Unit number Heating load Cooling load Total load Star rating IVFJBOJVYB EU9D54SZNA 3DSVZT89J8

Nationwide House Energy Rating Scheme (NatHERS) is an initiative of the Australian, state and territory governments. For more details see www.nathers.gov.au

Page 1 of 4

Nationwide House Energy Rating Scheme\* — Class 2 summary Certificate Number: LSOP26EFMV Date of Certificate: 11 May 2018 ★ Average star rating: 7.7 HOUSE

Annual thermal performance loads (MJ/m2)

Certificate number Unit number Heating load Cooling load Total load Star rating

Summary of all dwellings continued

PTIN8YQKA9

Nationwide House Energy Rating Scheme (NatHERS) is an initiative of the Australian, state and territory governments. For more details see www.natihera.gov.au



Page 2 of 4

Nationwide House Energy Rating Scheme\* — Class 2 summary



Certificate Number: LSOP26EFMV Date of Certificate: 11 May 2018 ★ Average star rating: 7.7 HOUSE

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## Nationwide House Energy Rating Scheme\* — Class 2 summary

Certificate Number: LSOP26EFMV Date of Certificate: 11 May 2018 ★ Average star rating: 7.7 HOUSE

Page 4 of 4

### Summary of all dwellings continued

ertification details or					
		Annual the	rmal performance load	ds (MJ/m2)	_
Certificate number	Unit number	Heating load	Cooling load	Total load	Star ratin
L9F7FFIQFU	G06	8.3	10.7	19	8.6

## Summary of all dwellings continued

		Annual the	rmal performance loa	ds (MJ/m2)	_
Certificate number	Unit number	Heating load	Cooling load	Total load	Star rating
JNHVJ7D5B9	412	28.1	12.5	40.6	6.9
Z23O370B8Z	413	26.5	12	38.5	7
EOLW365UIQ	414	16.6	14	30.6	7.6
JN0K1EJV04	501	6.3	20.1	26.4	7.9
D4N30WSIZK	502	5.7	11.8	17.5	8.7
WZP4GTA6KS	503	4.5	16	20.5	8.4
D5USX6R28A	504	5.2	20.7	25.9	8
7YEPOHTFWV	505	4.5	19.2	23.7	8.2
EDQ56NCW1Z	506	4.7	14.4	19.1	8.6
IA0NP1ZH8Z	507	5.7	11.9	17.6	8.7
7D0XX59U2L	508	7.2	20	27.2	7.9
6UAKKYCQ4W	509	24.1	14.7	38.8	7
YSOLSCKRTP	510	29.8	12.9	42.7	6.7
09ZJJRTES5	511	29.6	12.6	42.2	6.7
4TJ2UY9PD0	512	30.7	12.8	43.5	6.6
YIMMBOYPEU	513	30	12.9	42.9	6.7
VSANQBAJV1	514	24.6	14.2	38.8	7
92DGX48OKE	601	36.7	13.2	49.9	6.1
FIAGEAG2JX	602	24.7	27.2	51.9	5.9
W6CNDBWU2I	603	21.1	20	41.1	6.8
8965GZQ3OC	604	18.2	20.7	38.9	7
JGE6WEITWQ	604	18.3	21.2	39.5	6.9
ACK7IC2KCT	606	21.2	20	41.2	6.8
ACXQMQVSI7	607	21.2	21.2	42.4	6.7
E6SBK7TC0D	608	39.2	14.7	53.9	5.8
LS3G13XQY5	G01	6.5	17	23.5	8.2
RHY9S359TT	G02	8.2	10.5	18.7	8.6
CSN3RTQKO4	G03	5.7	14.2	19.9	8.5
SL9725S7GU	G04	14.1	11.7	25.8	8
NJWNJ7HA5C	G05	9	13.4	22.4	8.3

Nationwide House Energy Rating Scheme (NatHERS) is an initiative of the Australian, state and territory governments. For more details see www.nathers.gov.su

\* Nationwide House Energy Rating Scheme (NatHERS) is an initiative of the Australian, state and territory governments. For more details see www.nathers.gov.su

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Seniors Living 5 Skyline Place Frenchs Forest NSW 2086


SP 49558

### **BASIX COMMITMENTS - 2**



SCALE:	AS SHOWN	DRAWING
SUBSET:	BASIX COMMITMENTS	DA902

DRAWN BY: FK/SU/WH ISSUE

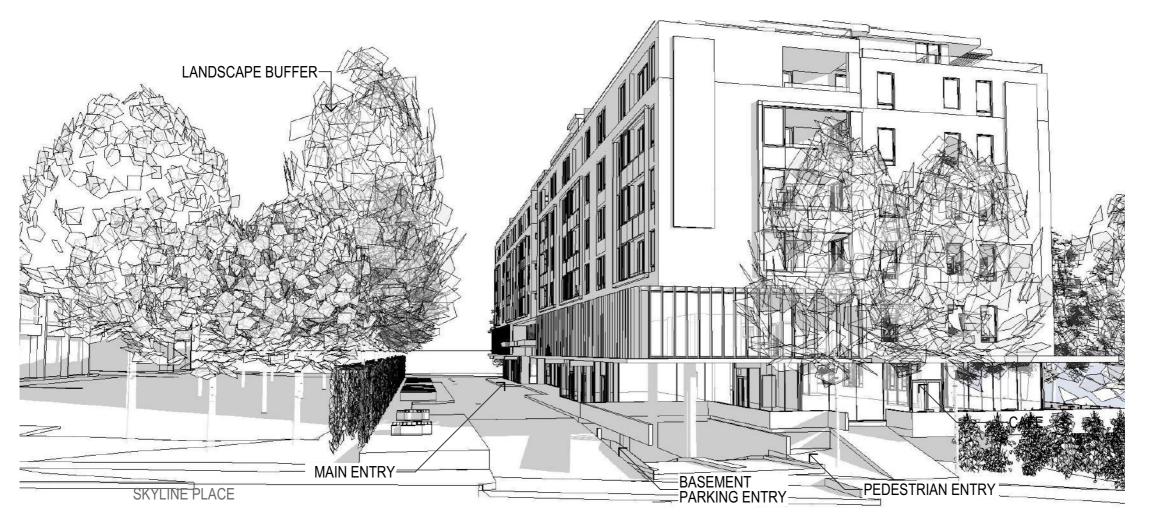



STREET VIEW - SKYLINE PLACE



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PROJECT:

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## **3D PERSPECTIVE**



SCALE:	AS SHOWN	DRAWING
SUBSET:	3D VIEWS	DA1001
DRAWN BY:	FK/SU/WH	ISSUE A





















LEVEL 2 20 YOUNG STREET NEUTRAL BAY NSW 2089
TEL: 8968 1900 properties@platino.com.au ACN: 603 389 288

SCALE: AS SHOWN
SHADOW
CHOSET SHADOW
CHOSET BASEN BA

Seniors Living 5 Skyline Place Frenchs Forest NSW 2086

**SHADOW DIAGRAMS** 

28.03.18

A ORIGINAL ISSUE

ISSUE REVISIONS
PROJECT:

SP 49558


 DRAWN BY:
 FK/SU/WH
 ISSUE

 FILE:
 BIM Server:
 BIM21 - BIM Server 21/SKY5 (DA) Staged

Unit Type	Home Story	Unit Name	Area	Quantit
02	BASEMENT	Carpark	2,526	1
02	LOWER GROUND	Carpark	2,669	1
		_	5,195 m²	
2 BED	GROUND FLOOR	A	98	1
2 BED	GROUND FLOOR	A	98	1
2 BED	GROUND FLOOR	A	98	1
2 BED 2 BED	GROUND FLOOR GROUND FLOOR	A A	98 98	1
2 BED	GROUND FLOOR	A1	122	1
2 BED	LEVEL 1	A	98	1
2 BED	LEVEL 1	A	98	1
2 BED	LEVEL 1	Α	98	1
2 BED	LEVEL 1	Α	98	1
2 BED	LEVEL 1	Α	98	1
2 BED	LEVEL 1	Α	98	1
2 BED	LEVEL 1	A1	122	1
2 BED	LEVEL 1	A1	122	1
2 BED	LEVEL 2	A	98	1
2 BED	LEVEL 2	A	98	1
2 BED	LEVEL 2	A	98	1
2 BED 2 BED	LEVEL 2 LEVEL 2	A A1	98 122	1
2 BED	LEVEL 2	A1	122	1
2 BED	LEVEL 2	A2	103	1
2 BED	LEVEL 2	A2 A2	103	1
2 BED	LEVEL 2	B	132	1
2 BED	LEVEL 2	В	132	1
2 BED	LEVEL 2	N	110	1
2 BED	LEVEL 2	N	110	1
2 BED	LEVEL 2	0	118	1
2 BED	LEVEL 2	0	118	1
2 BED	LEVEL 3	Α	98	1
2 BED	LEVEL 3	Α	98	1
2 BED	LEVEL 3	Α	98	1
2 BED	LEVEL 3	Α	98	1
2 BED	LEVEL 3	A1	122	1
2 BED	LEVEL 3	A1	122	1
2 BED 2 BED	LEVEL 3	A2 A2	103 103	1
2 BED	LEVEL 3	B B	132	1
2 BED	LEVEL 3	В	132	1
2 BED	LEVEL 3	N	110	1
2 BED	LEVEL 3	N	110	1
2 BED	LEVEL 3	0	118	1
2 BED	LEVEL 3	0	118	1
2 BED	LEVEL 4	Α	98	1
2 BED	LEVEL 4	Α	98	1
2 BED	LEVEL 4	Α	98	1
2 BED	LEVEL 4	Α	98	1
2 BED	LEVEL 4	A1	122	1
2 BED	LEVEL 4	A1	122	1
2 BED	LEVEL 4	A2	103	1
2 BED 2 BED	LEVEL 4	A2	103 132	1
2 BED	LEVEL 4 LEVEL 4	B B	132	1
2 BED	LEVEL 4	N	110	1
2 BED	LEVEL 4	N N	110	1
2 BED	LEVEL 4	0	118	1
2 BED	LEVEL 4	0	118	1
2 BED	LEVEL 5	A	98	1
2 BED	LEVEL 5	A	98	1
2 BED	LEVEL 5	А	98	1
2 BED	LEVEL 5	Α	98	1
2 BED	LEVEL 5	A1	122	1
2 BED	LEVEL 5	A1	122	1
2 BED	LEVEL 5	A2	103	1
2 BED	LEVEL 5	A2	103	1
2 BED	LEVEL 5	В	132	1
2 BED 2 BED	LEVEL 5 LEVEL 5	B N	132	1
2 BED	LEVEL 5	N N	110 110	1
2 BED	LEVEL 5	0	118	1
2 BED	LEVEL 5	0	118	1
2 BED	LEVEL 6	P	133	1
2 BED	LEVEL 6	P	133	1
2 BED	LEVEL 6	Q	145	1
2 BED	LEVEL 6	Q	145	1
2 BED	LEVEL 6	R	154	1
2 BED	LEVEL 6	R	154	1
2 BED	LEVEL 6	S	130	1
2 BED	LEVEL 6	S	130	1
2 BED	ROOF LEVEL	CLERESTORY	4	1
2 BED	ROOF LEVEL	CLERESTORY	39	1
2 BED	ROOF LEVEL	CLERESTORY	39	1
			8,898 m²	78
COMMON	ROOF LEVEL	COMMON 6	56 <b>56 m²</b>	





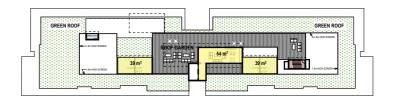

LEVEL 5

**ROOF LEVEL** 





LEVEL 4

LEVEL 6




LEVEL 3



LEVEL 2



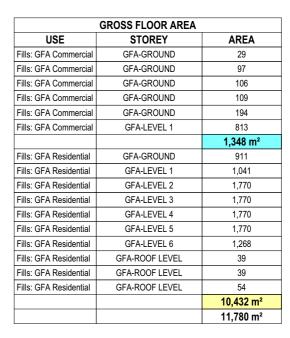

SITE AREA = 4,726m<sup>2</sup>
PROPOSED FLOOR SPACE RATIO = (11,780:4,726) OR 2.5:1

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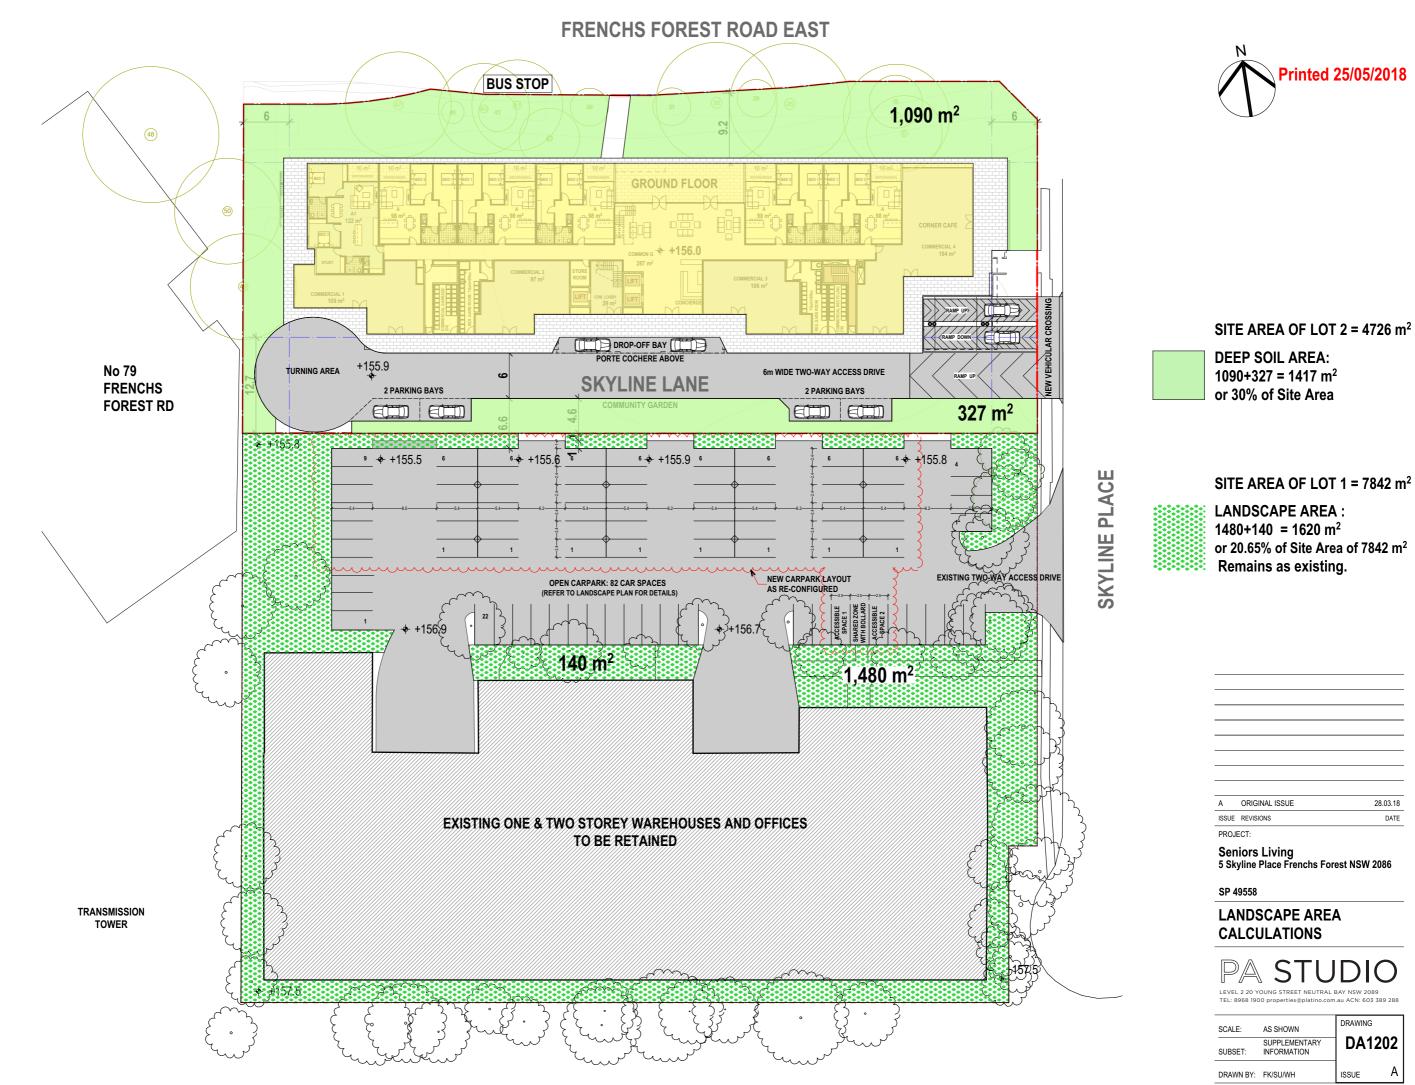
## FLOOR AREA CALCULATIONS



SCALE:	AS SHOWN	DRAWING
SUBSET:	SUPPLEMENTARY INFORMATION	DA1201
DRAWN BY:	FK/SU/WH	ISSUE A


TOTAL 2 BED UNITS








**VEGETATION** 

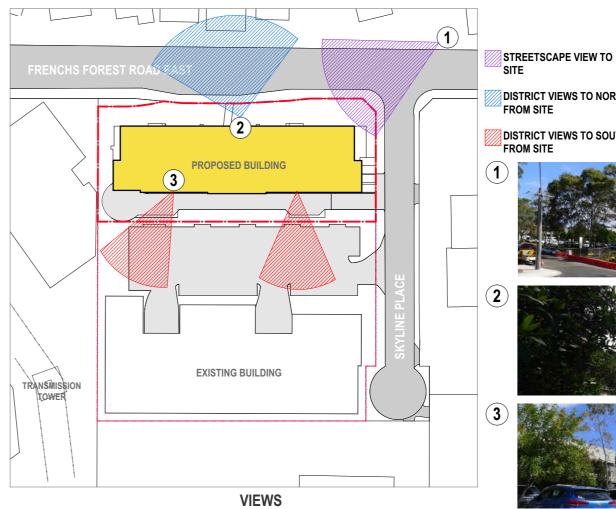

77% OF UNITS WITH LIVING SPACES ORIENTED NORTH **∼** PREVAILING WINDS PLEASANT BREEZES **EXISTING BUILDING** 

**MICROCLIMATE** 

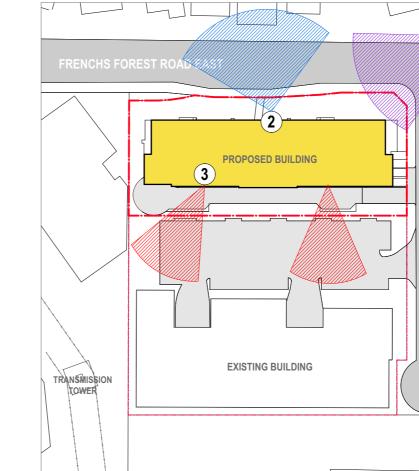

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DISTRICT VIEWS TO NORTH FROM SITE

DISTRICT VIEWS TO SOUTH FROM SITE







BUS STOP


VEHICLE DROP OFF POINT

STREET PARKING

COVERED/AWNING

**→** PEDESTRIAN CIRCULATION

→ VEHICLE CIRCULATION

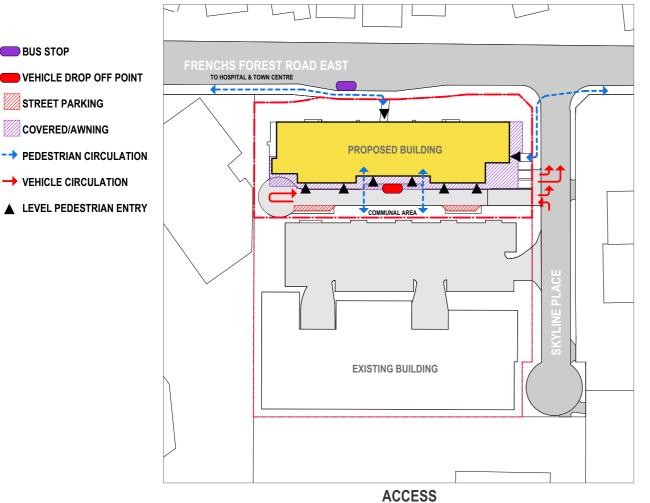


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SITE ANALYSIS: TREES, **VIEWS, ACCESS, CLIMATE** 

DRAWING SCALE: AS SHOWN **DA102** SITE ANALYSIS SUBSET: DRAWN BY: FK/SU/WH






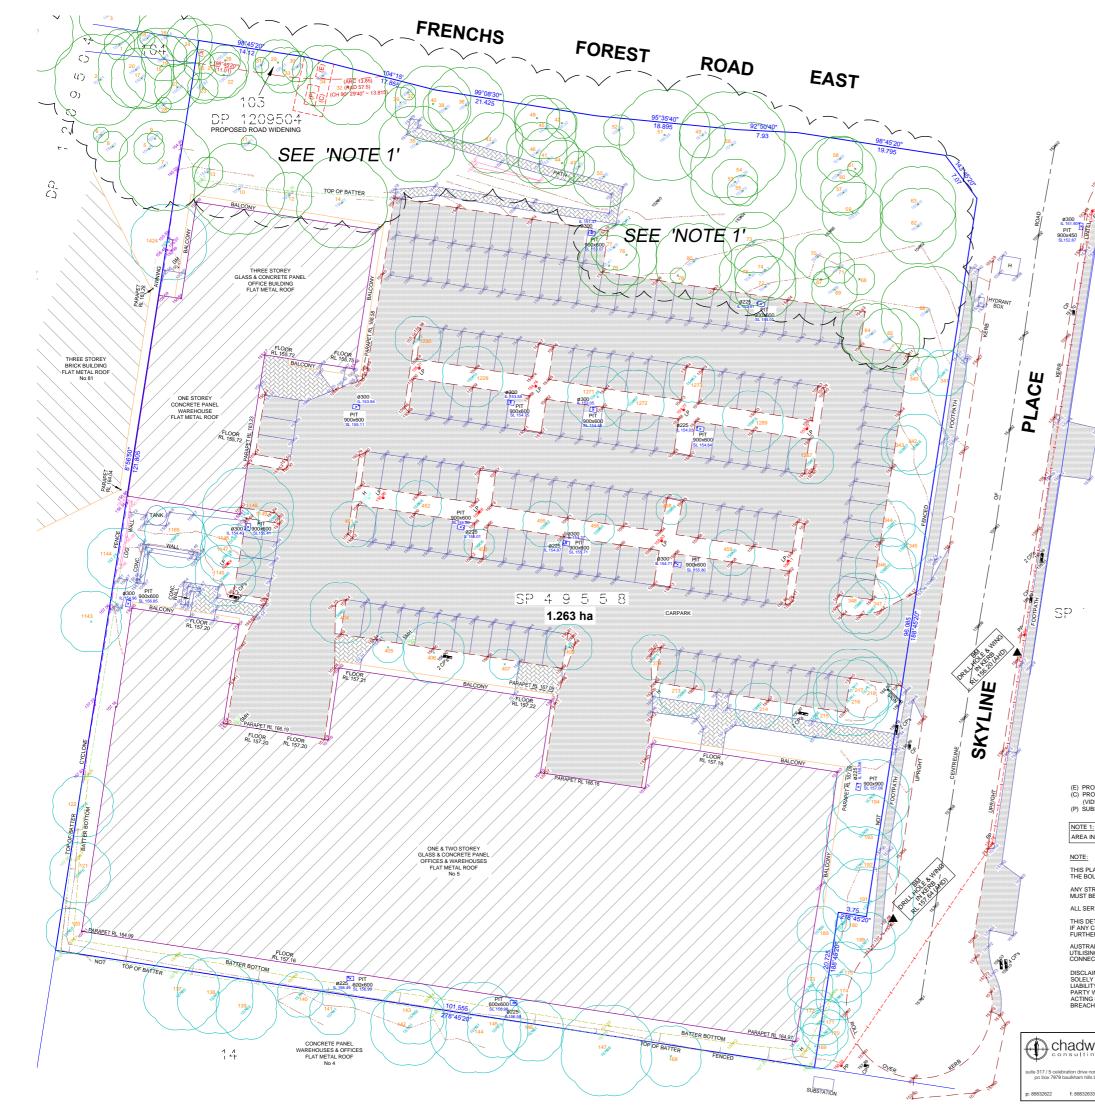

NO INVESTIGATION OF UNDERGROUND SERVICES HAS BEEN MADE. ALL RELEVANT AUTHORITIES SHOULD BE NOTIFIED PRIOR TO ANY EXCAVATION ON OR NEAR THE SITE

DEVELOPERS & EXCAVATORS MAY BE HELD FINANCIALLY RESPONSIBLE BY THE ASSET OWNER SHOULD THEY DAMAGE UNDERGROUND NETWORKS.

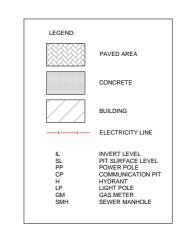

(E) PROPOSED EASEMENT FOR ELECTRICITY PURPOSES 2 WIDE (VIDE DP1174210) (C) PROPOSED RIGHT OF WAY & EASEMENT FOR ELECTRICITY PURPOSES 2 & 4 WID (VIDE DP1174210) (P) SUBSTATION PREMISES No 16373 (VIDE DP1174210)

AREA INACCESSIBLE. DETAIL INFORMATION FROM SURVEY DATED 26.09.2015

THIS PLAN IS PREPARED FOR DETAIL AND LEVEL PURPOSES ONLY AND AS SUCH THE BOUNDARIES OF THE LAND HAVE NOT BEEN SURVEYED OR MARKED.

ANY STRUCTURES RELATED TO PHYSICAL FEATURES (BUILDINGS, TREES, ETC.) MUST BE CONFIRMED PRIOR TO FINAL DESIGN.

ALL SERVICES MUST BE VERIFIED BY THE CONTRACTOR PRIOR TO CONSTRUCTION. THIS DETAIL SURVEY IS NOT A "SURVEY" AS DEFINED BY THE SURVEYORS ACT 1929. IF ANY CONSTRUCTION IS PLANNED IT WOULD BE ADVISABLE TO CARRY OUT FURTHER SURVEY WORK TO DETERMINE THE BOUNDARY DIMENSIONS.

AUSTRALIAN HEIGHT DATUM (AHD) HAS BEEN OBTAIN FROM GNSS OBSERVATIONS UTILISING CORS ARE 1-NSW. IF AHD HEIGHT IS CRITICAL ADDITIONAL SURVEY CONNECTIONS TO LOCAL CO-ORDINATED MARKS SHOULD BE MAD

DISCLAIMER OF LIABILITIES TO ANY THIRD PARTIES: THIS PLAN IS MADE SOLELY FOR THE USE AND BENEFIT OF THE CLIENT NAMED ABOVE AND NO LIABILITY OR RESPONSIBILITY WHATOSOEVER IS ACCEPTED TO ANY THIRD PARTY WHO MAY RELY ON THIS PLAN WHOLLY OR IN PART. ANY THIRD PARTIES ACTING OR RELYING OF THIS PLAN WHETHER WHOLLY OR IN PART ARE IN BREACH OF OUR COPYRIGHT AND DO SO AT THEIR OWN RISK.

,	⊕ ci	nadwic	kcheng	PLAN SHOWING DETAILS & LEVELS OVER SP 49558 AT No 5 SKYLINE PLACE, FRENCHS FOREST		SHEET (	1 OF SHEETS	
			business park nsw 2153 ess centre nsw 2153	AHD RATIO: 1			REFEREN	
	p: 88832622	f: 88832633	e: admin@cca.net.au	11.1 DATE:			37125 /	D-MGA

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PROJECT:			


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## **SURVEY PLAN**



SCALE:	AS SHOWN	DRAWING
SUBSET:	SUPPLEMENTARY INFORMATION	DA1203
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**GROUND FLOOR PLAN** 



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## **GROUND FLOOR PLANS OF EXISTING BUILDINGS**

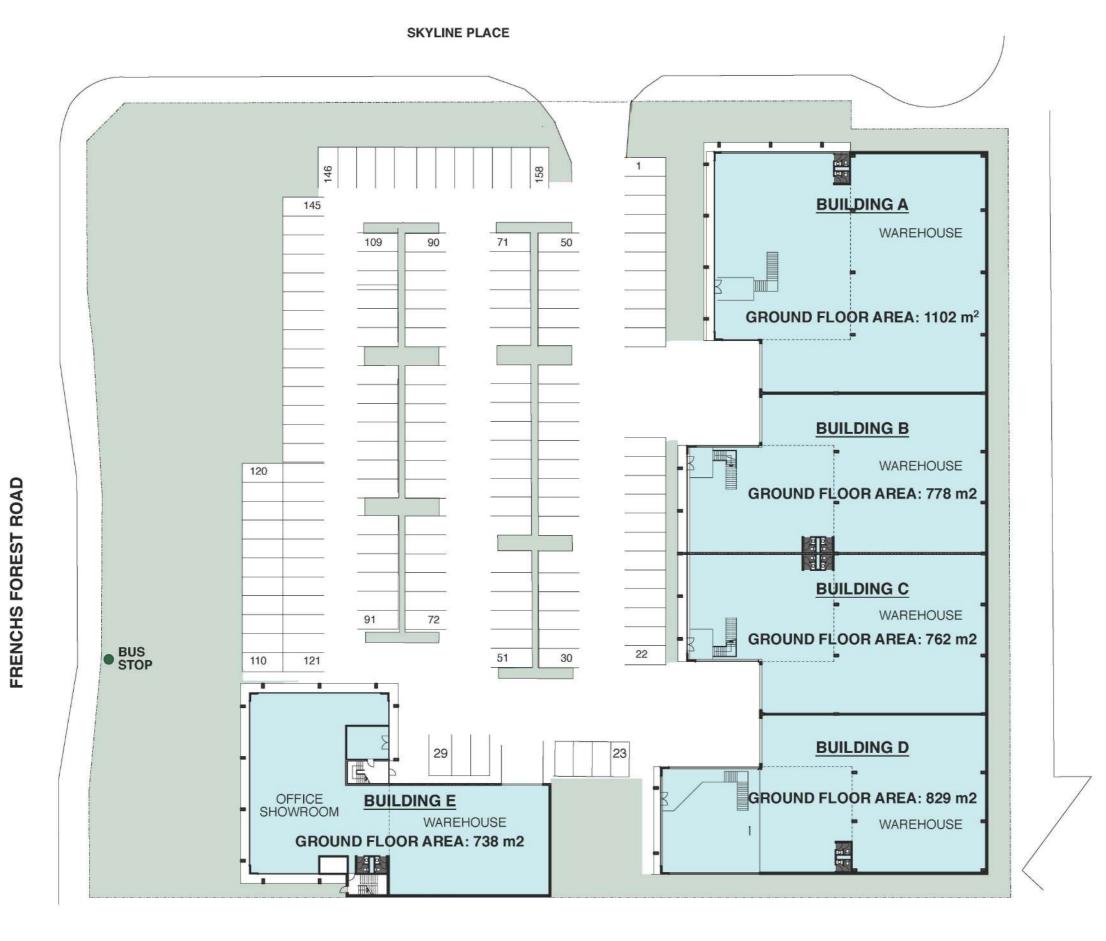

AS SHOWN

**DA1204** 


FILE: BIM Server: BIM21 - BIM Server 21/SKY5 (DA) Staged




5 skyline place, frenchs forest

scale 1:500 @A3

28/06/11

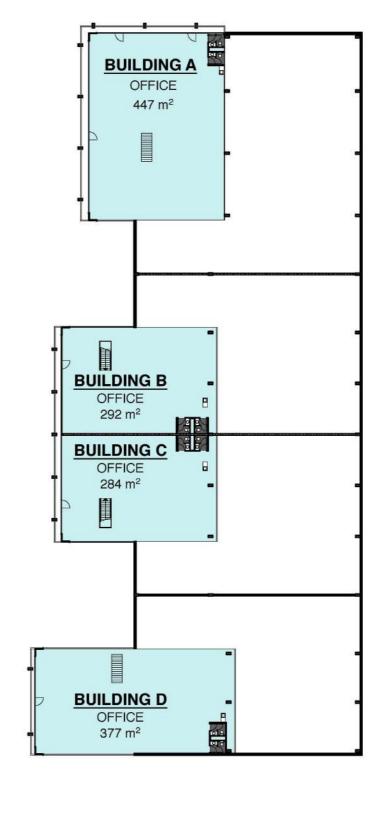

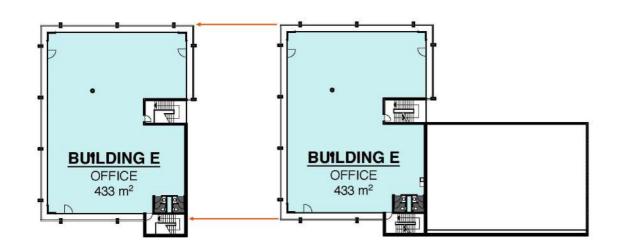

## LEVEL 2



5 skyline place, frenchs forest

scale 1:500 @ A3 28/06/11 **LEVEL 1** 



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FIRST FLOOR PLANS OF **EXISTING BUILDINGS** 



SCALE:	AS SHOWN	DRAWING
SUBSET:	SUPPLEMENTARY INFORMATION	DA1205
DRAWN BY:	FK/SU/WH	ISSUE A





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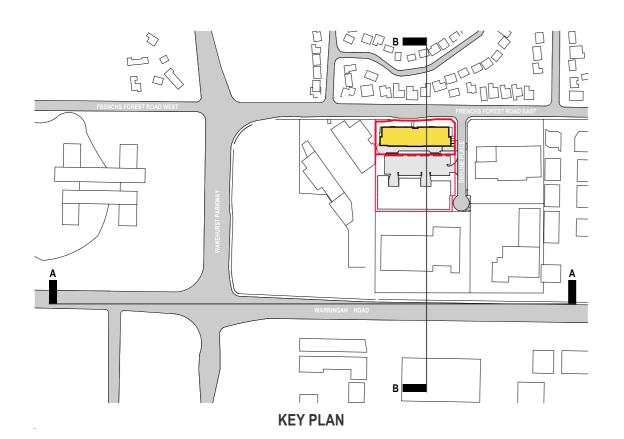
## SITE ANALYSIS: CONTEXT -**BUILT FORM PLAN**

SCALE: AS SHOWN **DA103** SUBSET: SITE ANALYSIS DRAWN BY: FK/SU/WH


1:5000 **CONTEXT - BUILT FORM PLAN** SP 49558

\* HEIGHTS IN METERS ABOVE GROUND LEVEL


\*\* FUTURE HEIGHTS AS INDICATED IN THE 'NORTHERN BEACHES HOSPITAL PRECINCT STRUCTURE PLAN' AS SHOWN BELOW:





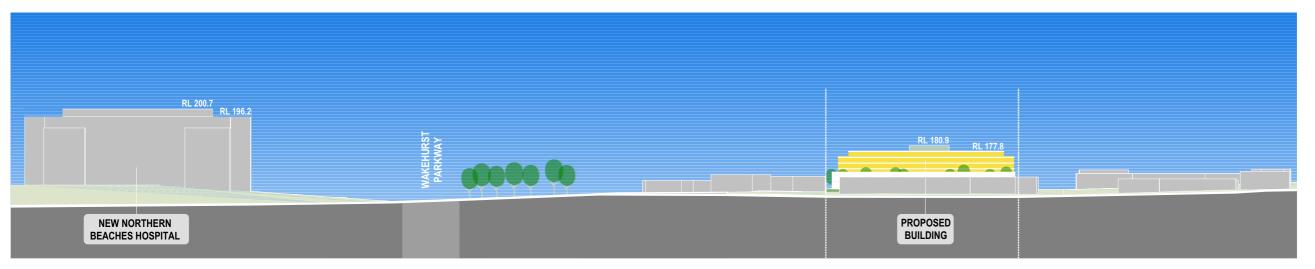

SECTION A LOOKING NORTH 1:2000

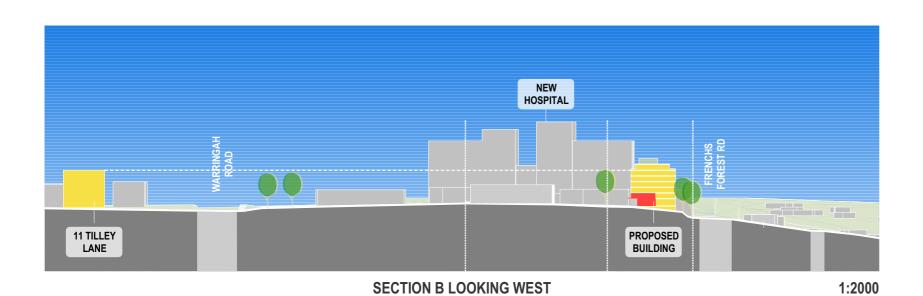

SITE ANALYSIS: CONTEXT -BUILT FORM SECTIONS

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28.03.18

DATE

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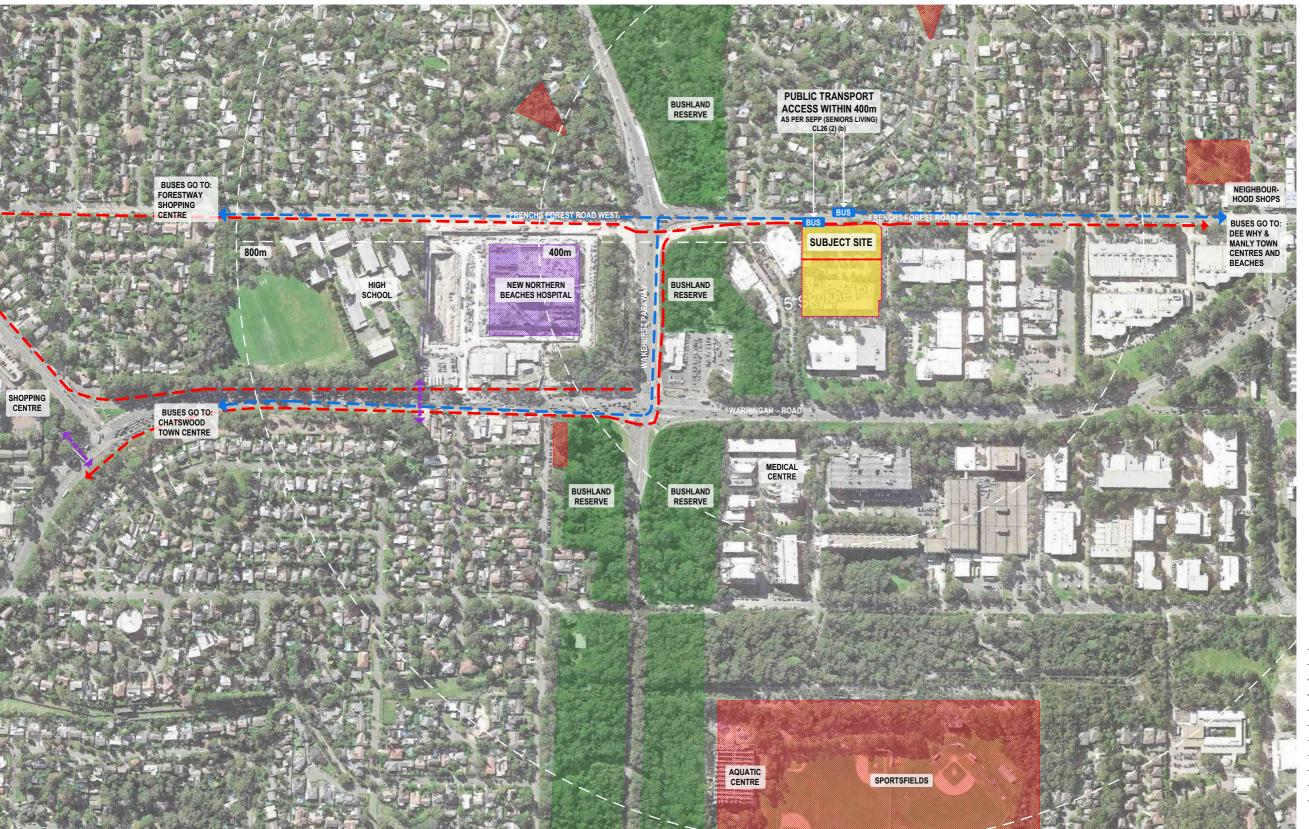
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PROJECT:

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SCALE:	AS SHOWN	DRAWING
SUBSET:	SITE ANALYSIS	DA104
DDAMAL DV	SITE ANALISIS	100115 Д





FROJECT.

1:5000

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## SITE ANALYSIS: CONTEXT - ACCESS PLAN



TEL: 8968 1900 properties@platino.com.au ACN: 603 389

SCALE: AS SHOWN

DRAWING

SCALE: AS SHOWN

SUBSET: SITE ANALYSIS

DRAWN BY: FK/SU/WH

ISSUE

A

FILE: BIM Server: BIM21 - BIM Server 21/SKY5 (DA) Staged

CONTEXT - ACCESS PLAN


OPEN SPACE

**BUS BUS STOP** 

─ BUS ROUTE


PLANNED SHARED PATH SUITABLE FOR PEDESTRIAN AND WHEELED ACCESS

PEDESTRIAN BRIDGE OVER ROAD

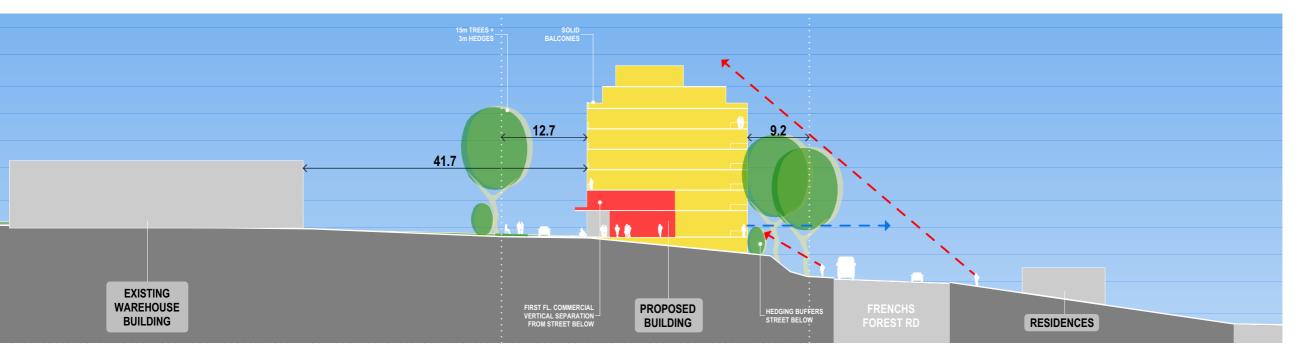

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## SECTION B NEIGHBOUR INTERFACES

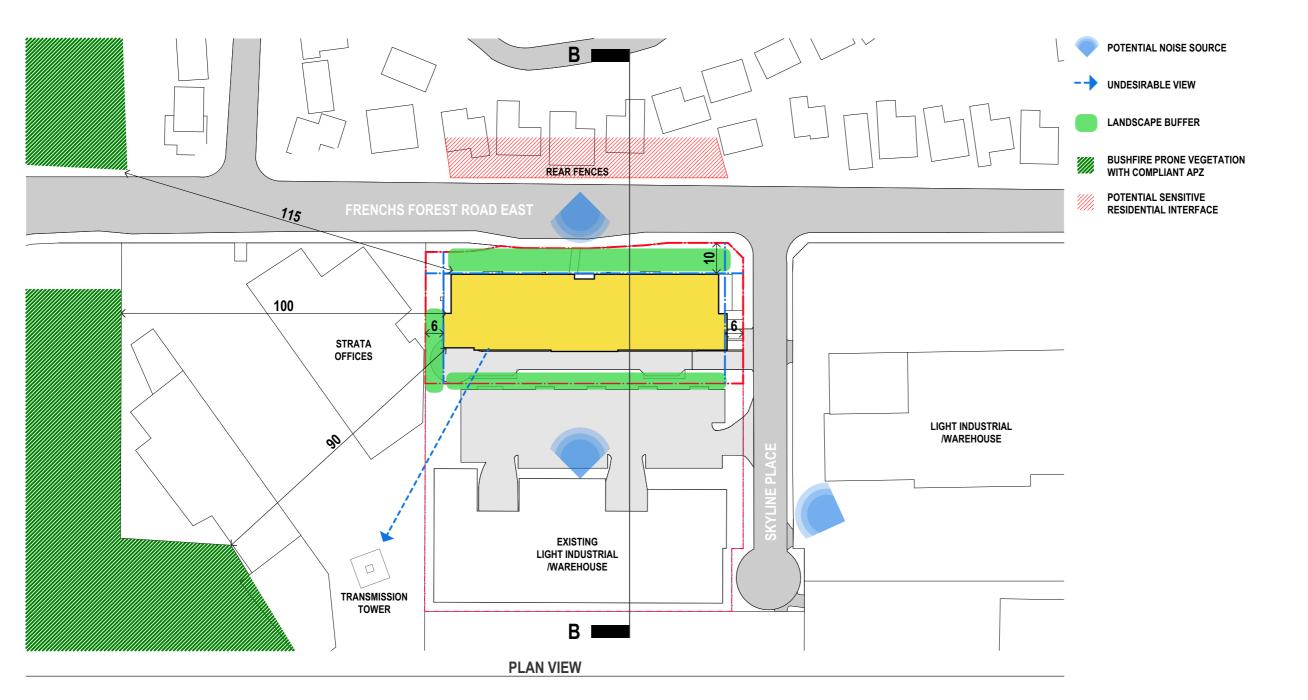

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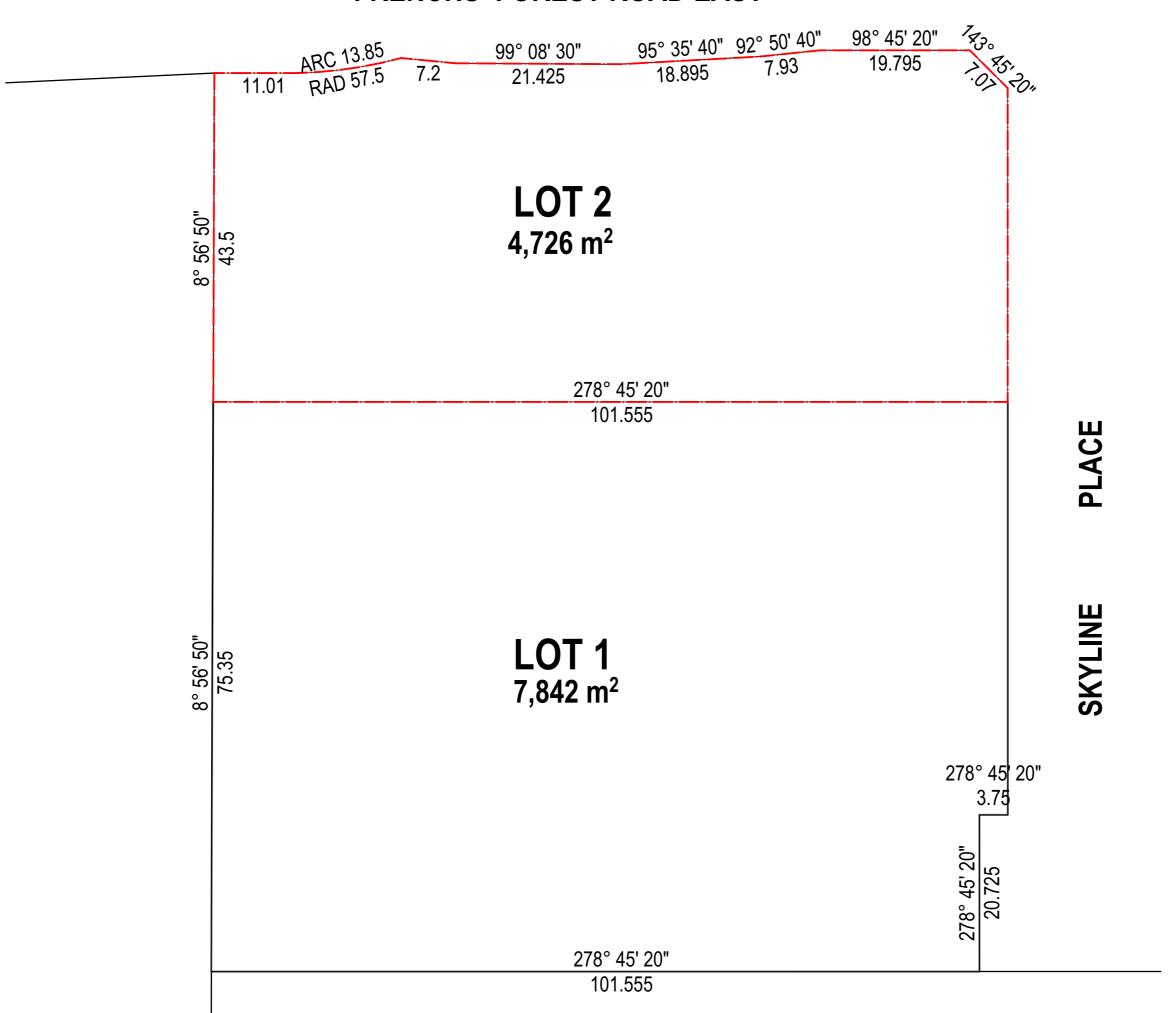
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## SITE ANALYSIS: CONTEXT - NEIGHBOUR INTERFACES



SCALE:	AS SHOWN	DRAWING
SUBSET:	SITE ANALYSIS	DA106
DRAWN BY:		ISSUE A

## FRENCHS FOREST ROAD EAST





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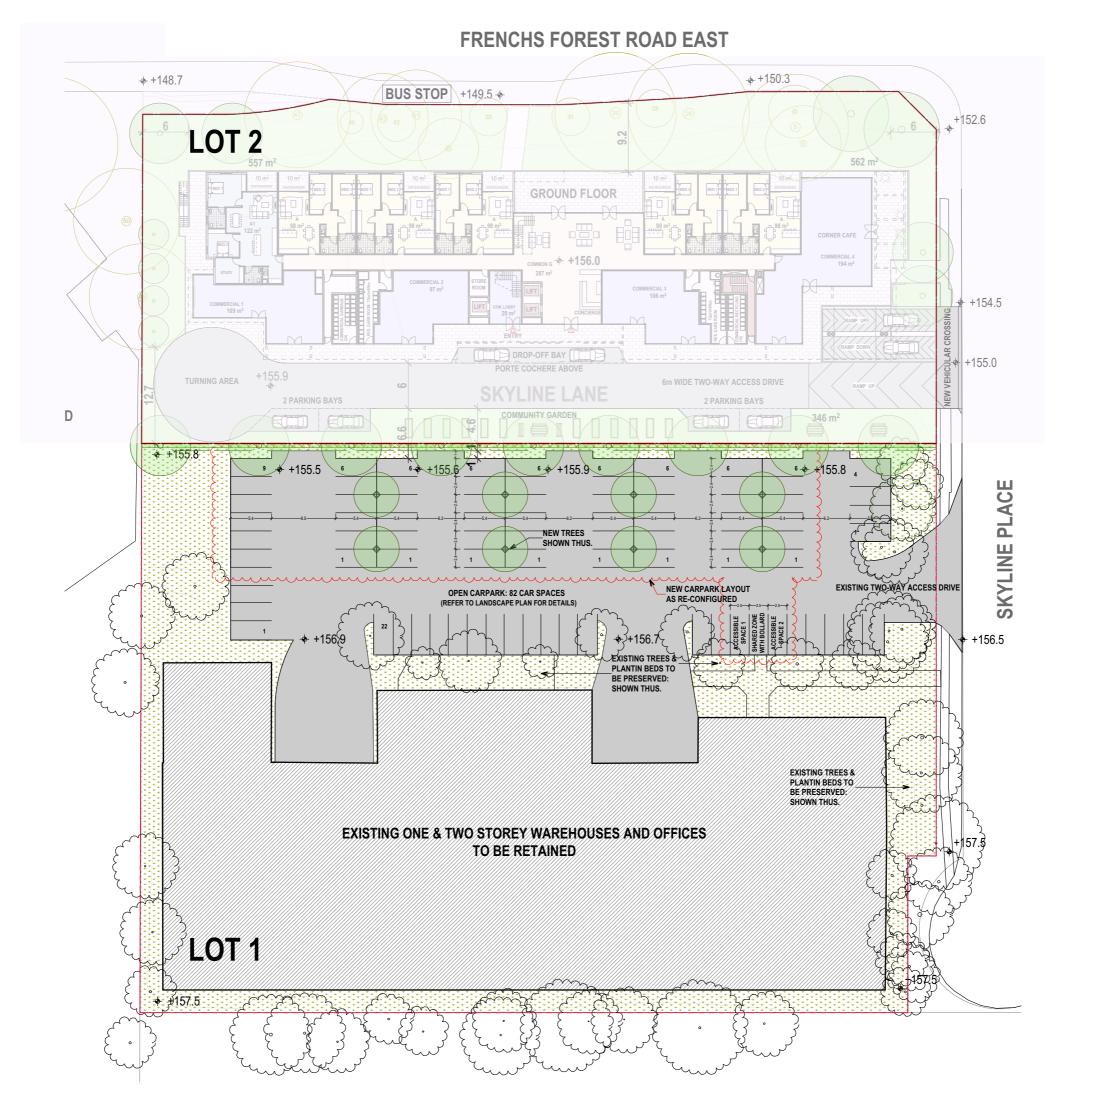
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## SUBDIVISION PLAN



SCALE:	AS SHOWN	DRAWING	
SUBSET:	SUBDIVISION	DA201	
DRAWN BY:	FK/SU/WH	ISSUE A	





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## **NEW WORKS ON LOT 1**



SCALE:	AS SHOWN	DRAWING
SUBSET:	SUBDIVISION	DA202
DRAWN BY:	FK/SU/WH	ISSUE A